Sheet Index					
Layout ID	Layout Name	Revision	Issued	Published	Remark
	Sheet Index			×	
A.01.1	Site Plan			×	
A.01.2	Foundation Plan			×	
A.01.3	Ground Floor Plan			×	
A.01.4	2. Terrace/Roof Plan			×	
A.02.1	E-01 Front Elavation			×	
A.02.2	E-02 Left End Elevation			×	
A.02.3	E-03 Rear End Elevation			×	
A.02.4	E-04 Right End Elevation			×	
A.03.1	Building Section!			×	
A.03.2	Building Section 2			×	
A.03.3	Building section 3			×	
A.03.4	Building Section 4			×	
A.03.5	Building Section 5			×	
A.03.6	Staircase Section			×	
A.03.7	Beam Layout			×	
E.01.1	Ground Floor Plan Electrical Lay			×	
P.01.1	Ground floor Plumbing Layout			×	
P.01.2	Terrace Plumbing Layout			×	
P.01.3	Septic Tank and Soakaway			×	
P.01.4	Inspection Chamber			×	
S.01.1	Door Schedule			×	
S.01.2	window schedule			×	
S.01.3	Wall schedule			×	
S.01.4	Beam/Trenches schedule			×	
S.01.5	Electrcal Schedule			×	



GREATER BANJUL THE GAMBIA

+220 3766269/2351601 Designed By: Structures Design Drawn by: A.H.Jow, A. O. Tamba & A. Marigo Checked by: A.H.Jow, A. O. Tamba & A. Marigo

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PROJECT SITE AREA: 1000m² Proposed Building Area: 285.448m²

DATE 5/22/2022

SCALE 1:0.60

Sheet Index





GREATER BANJUL THE GAMBIA

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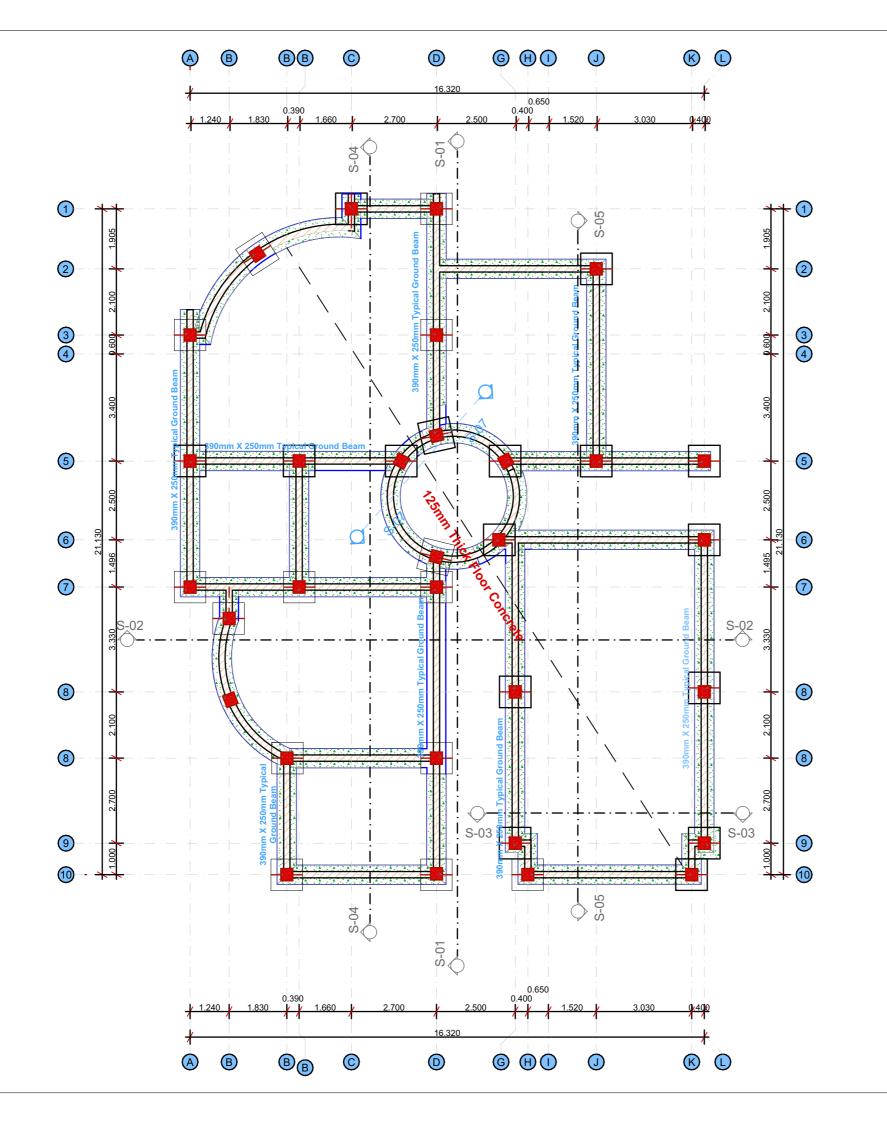
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SCALE 1:200

A.01.1 Site Plan





GREATER BANJUL THE GAMBIA

+220 3766269/2351601

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Drawn by: AH.Jow, A. O. Tamba & A. Marigo

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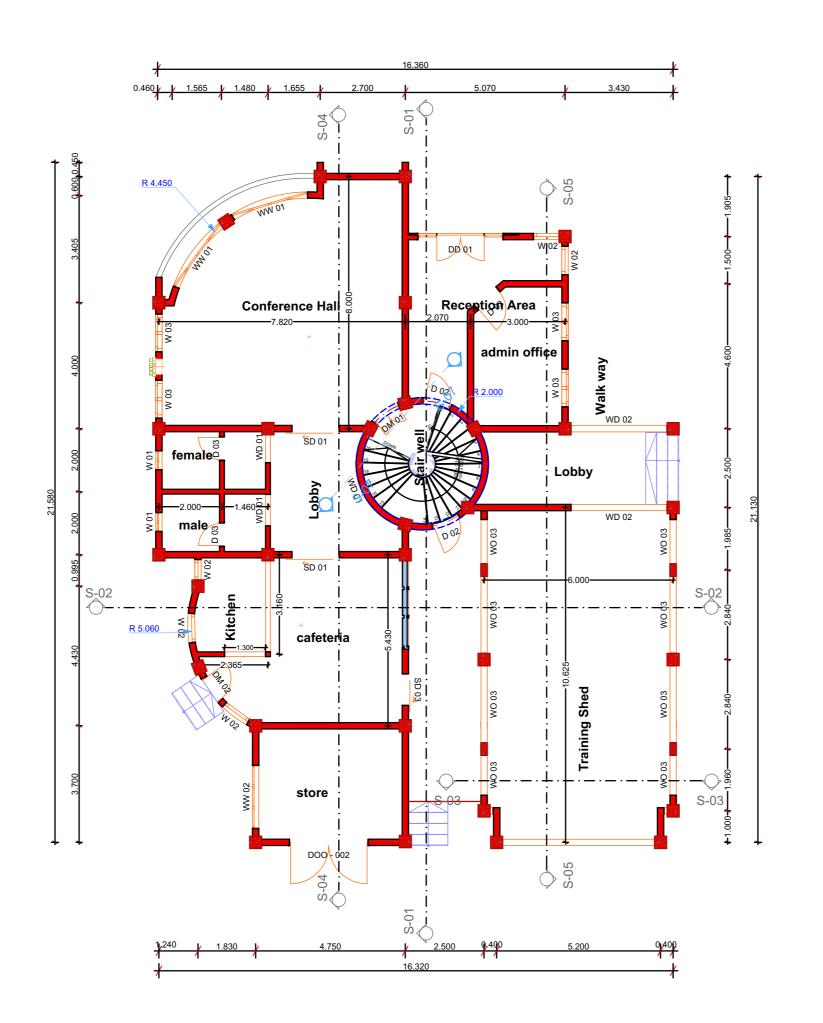
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PROJECT SITE AREA: 1000m²
Proposed Building Area: 285.448m²

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SCALE 1:120

A.01.2
Foundation Plan





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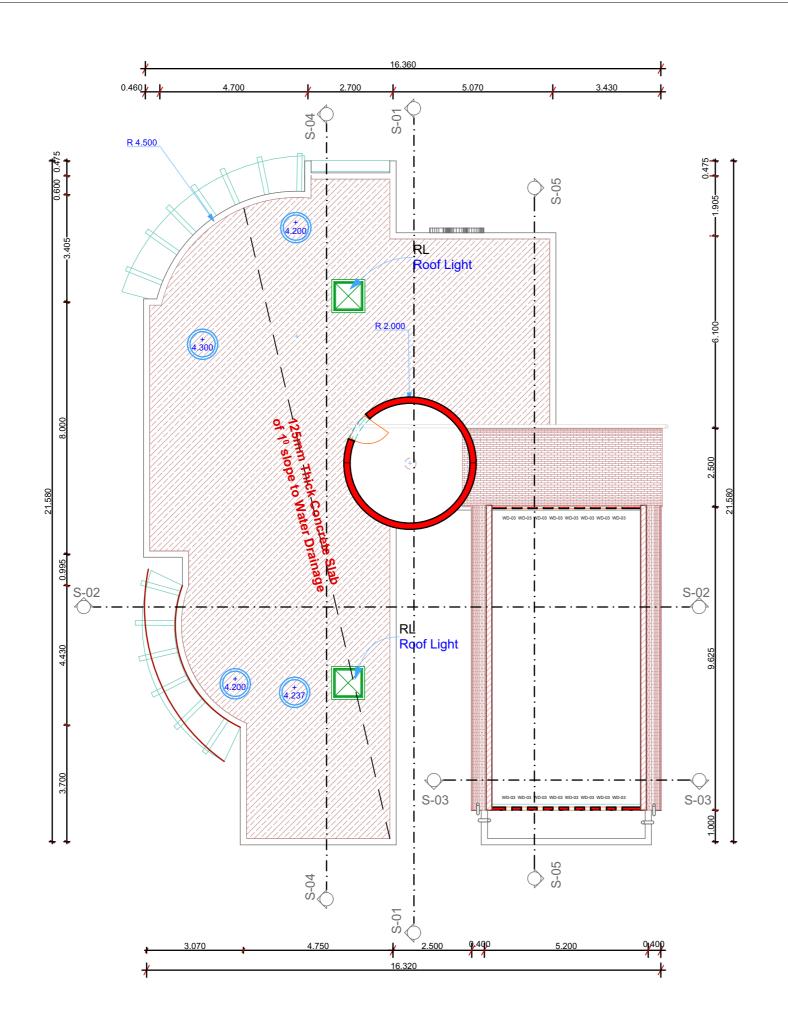
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PROJECT SITE AREA: 1000m² Proposed Building Area: 285.448m²

DATE 5/22/2022

SCALE 1:120

A.01.3 **Ground Floor Plan**





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THE GAMBIA

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A.01.4

2. Terrace/Roof Plan





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THE GAMBIA

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Proposed Building Area: 285.448m²

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SCALE 1:90

A.02.1 E-01 Front Elavation





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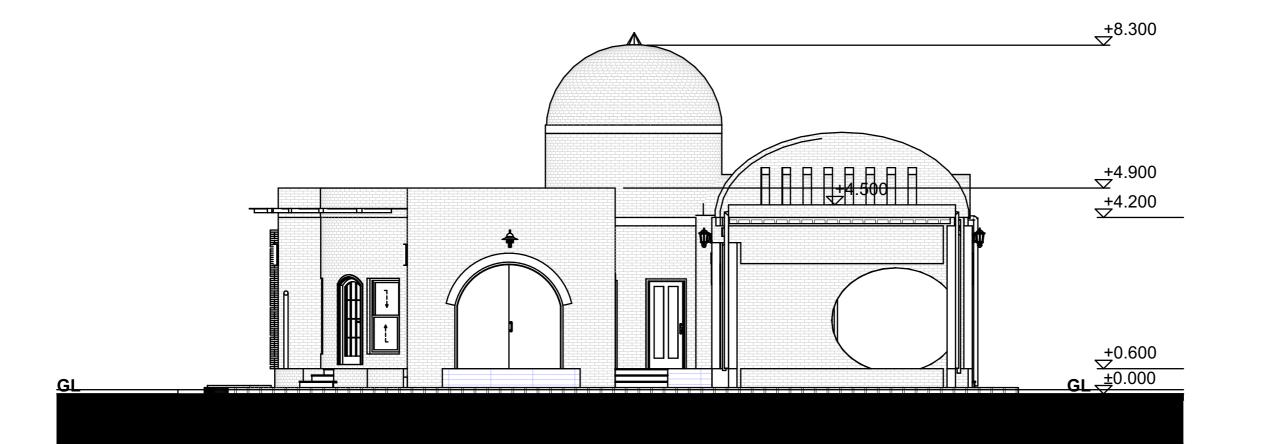
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Proposed Building Area: 285.448m²

DATE 5/22/2022

SCALE 1:90

A.02.2

E-02 Left End Elevation





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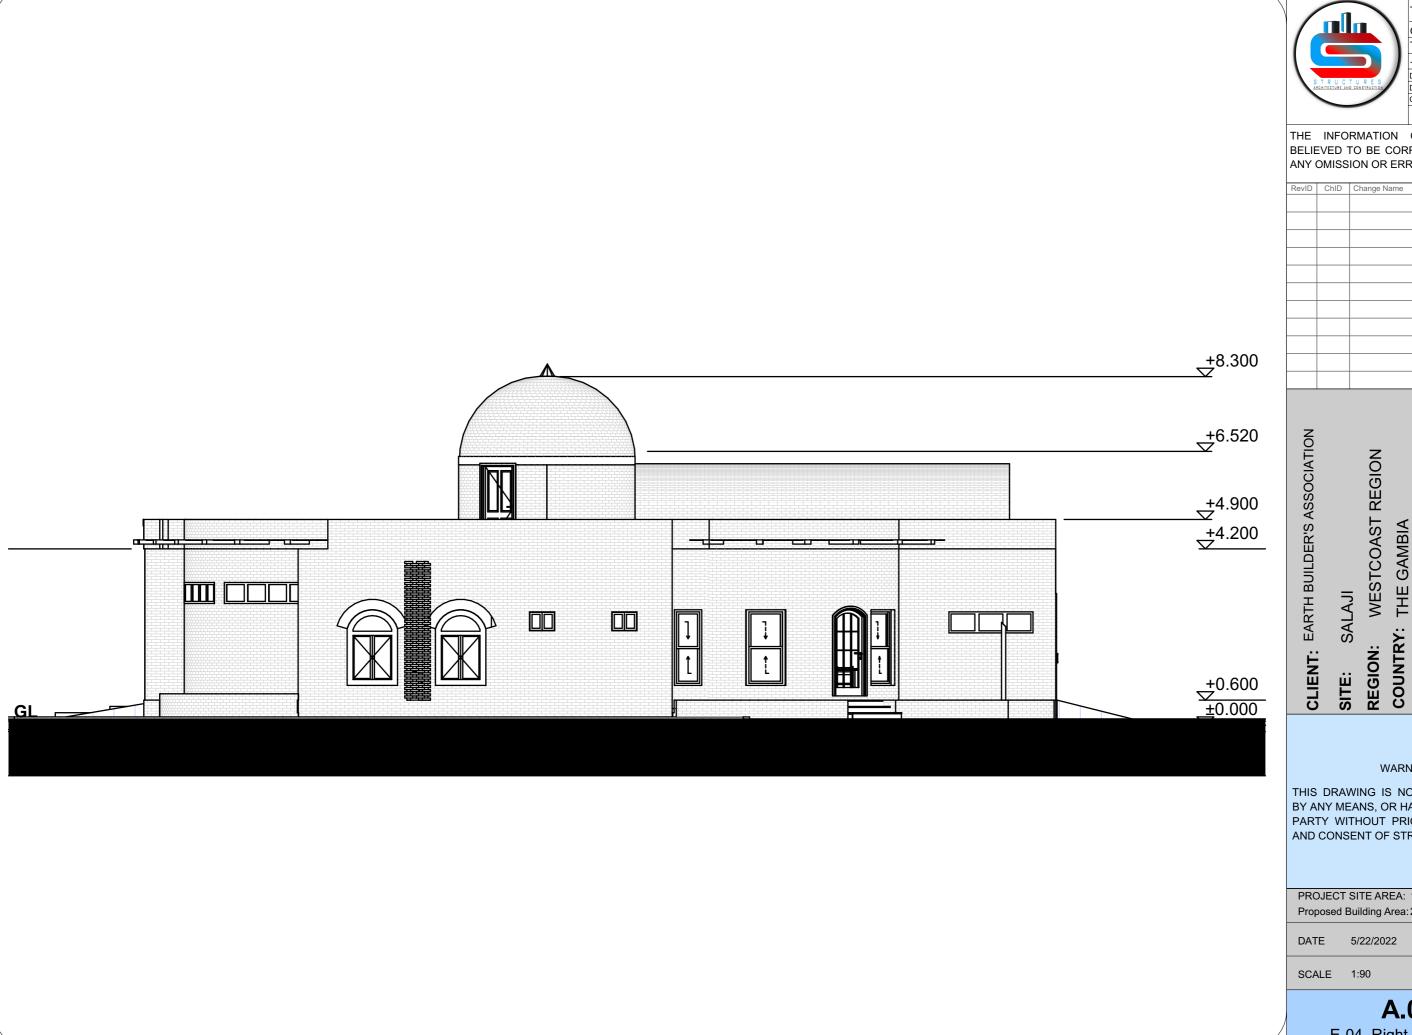
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SCALE 1:90

A.02.3

E-03 Rear End Elevation





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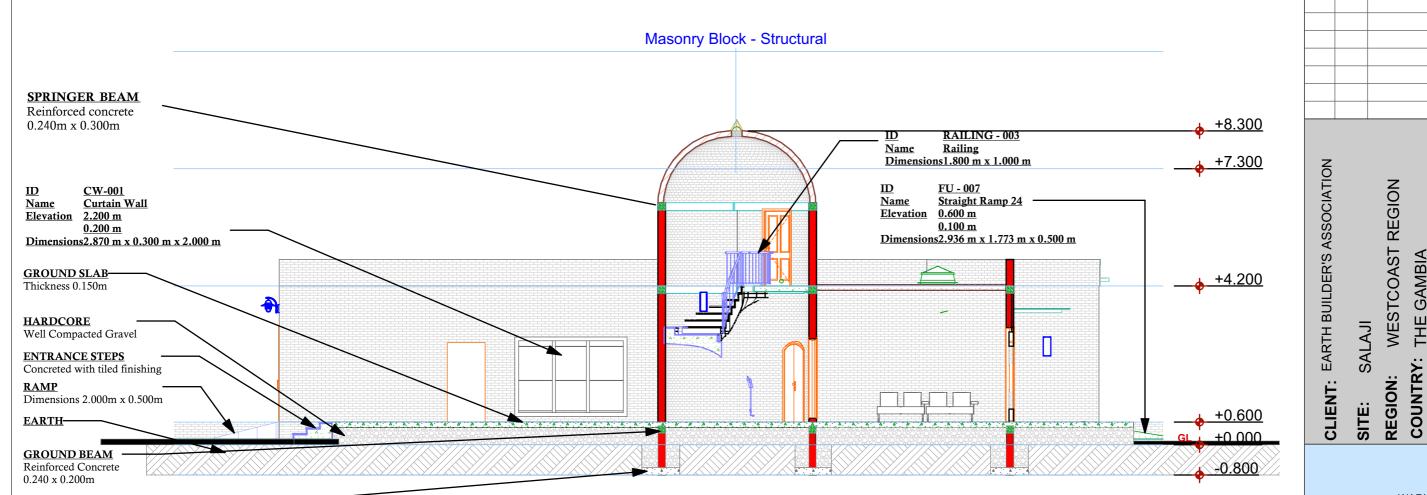
PROJECT SITE AREA: 1000m² Proposed Building Area: 285.448m²

5/22/2022

SCALE 1:90

A.02.4

E-04 Right End Elevation



FOUNDATION FOOTING-

Reinforced Concrete 1.000m x 1.000m x 0.200m



TOBOKOTO, KSMD

GREATER BANJUL
THE GAMBIA

+220 3766269/2351601

Designed By: Structures Design

Drawn by: A.H.Jow, A. O. Tamba & A. Marigo

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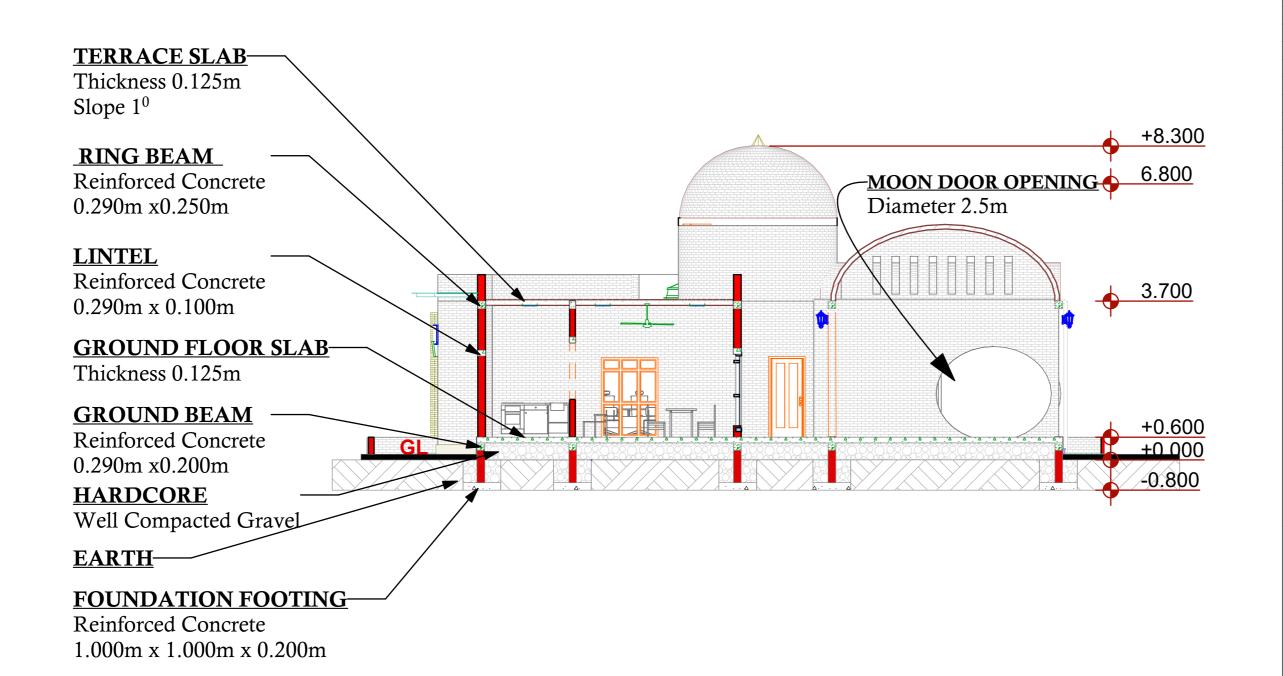
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PROJECT SITE AREA: 1000m²
Proposed Building Area: 285.448m²

DATE 5/22/2022

SCALE 1:100

A.03.1
Building Section!





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GREATER BANJUL
THE GAMBIA

+220 3766269/2351601
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Drawn by: A.H.Jow, A. O. Tamba & A. Marigo
Checked by: A.H.Jow, A. O. Tamba & A. Mari

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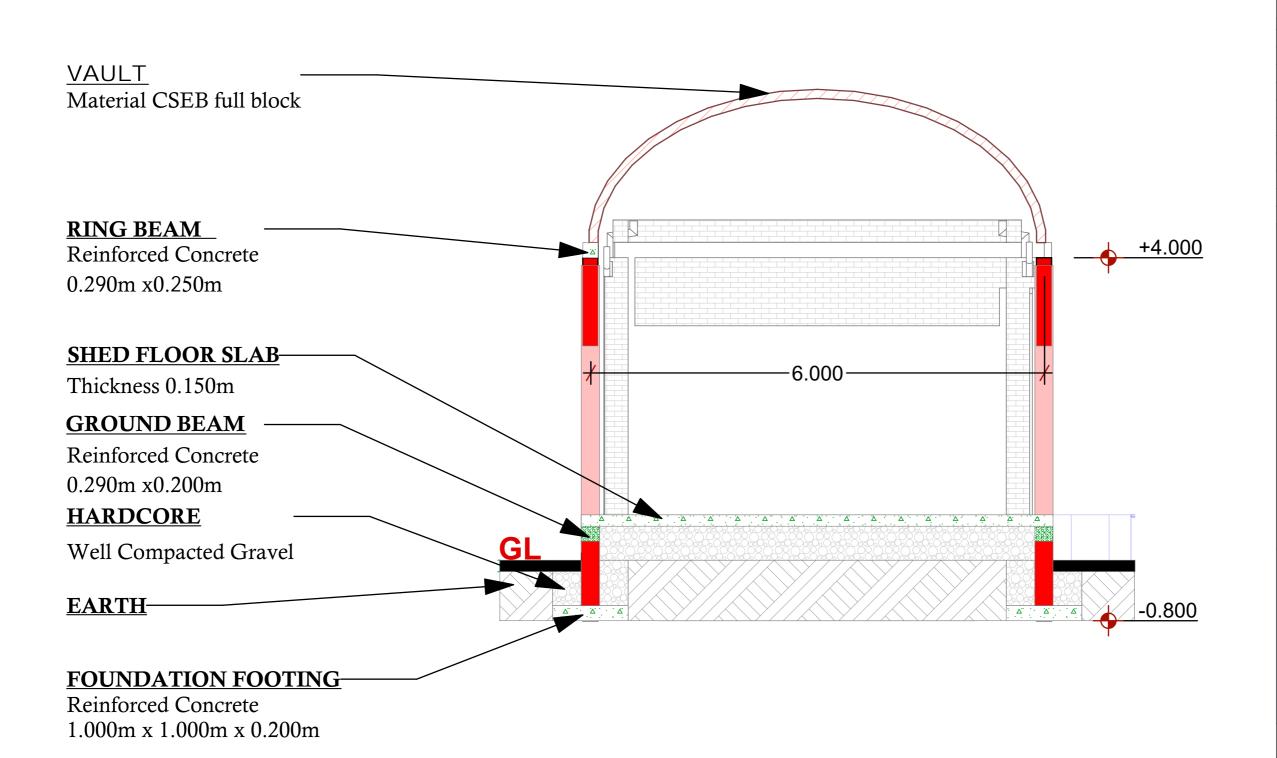
PROJECT SITE AREA: 1000m²
Proposed Building Area: 285.448m²

DATE 5/22/2022

SITE:

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A.03.2
Building Section 2





GREATER BANJUL
THE GAMBIA

+220 3766269/2351601

Designed By: Structures Design

Drawn by: A.H.Jow, A. O. Tamba & A. Marigo

Checked by: A.H.Jow, A. O. Tamba & A. Marigo

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PROJECT SITE AREA: 1000m²
Proposed Building Area: 285.448m²

DATE 5/22/2022

SCALE 1:50

A.03.3Building section 3





товокото, кѕмр

GREATER BANJUL
THE GAMBIA

+220 3766269/2351601

Designed By: Structures Design

Drawn by: AH.Jow, A. O. Tamba & A. Marigo

Checked by: AH.Jow, A. O. Tamba & A. Marigo

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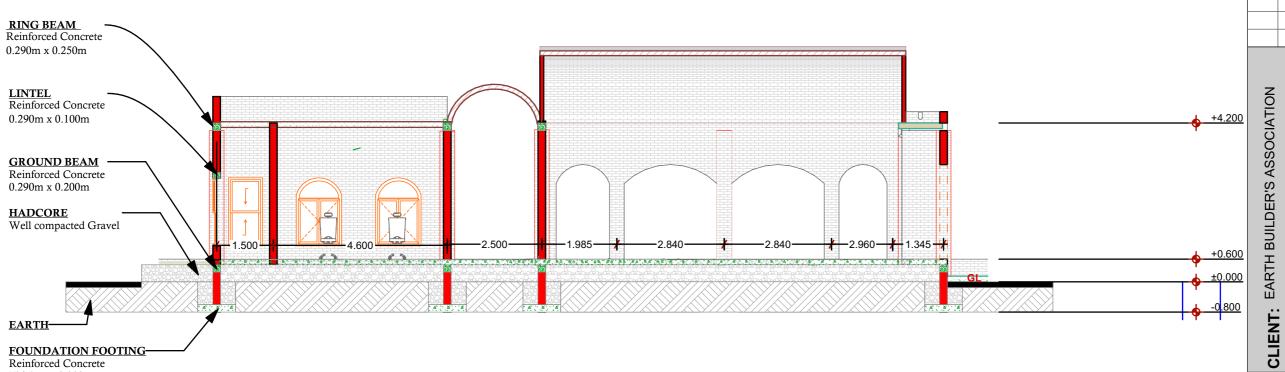
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Proposed Building Area: 285.448m²

DATE 5/22/2022

SCALE 1:100

A.03.4Building Section 4



Thickness 0.200m



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GREATER BANJUL
THE GAMBIA

+220 3766269/2351601

Designed By: Structures Design

Drawn by: A.H.Jow, A. O. Tamba & A. Marigo

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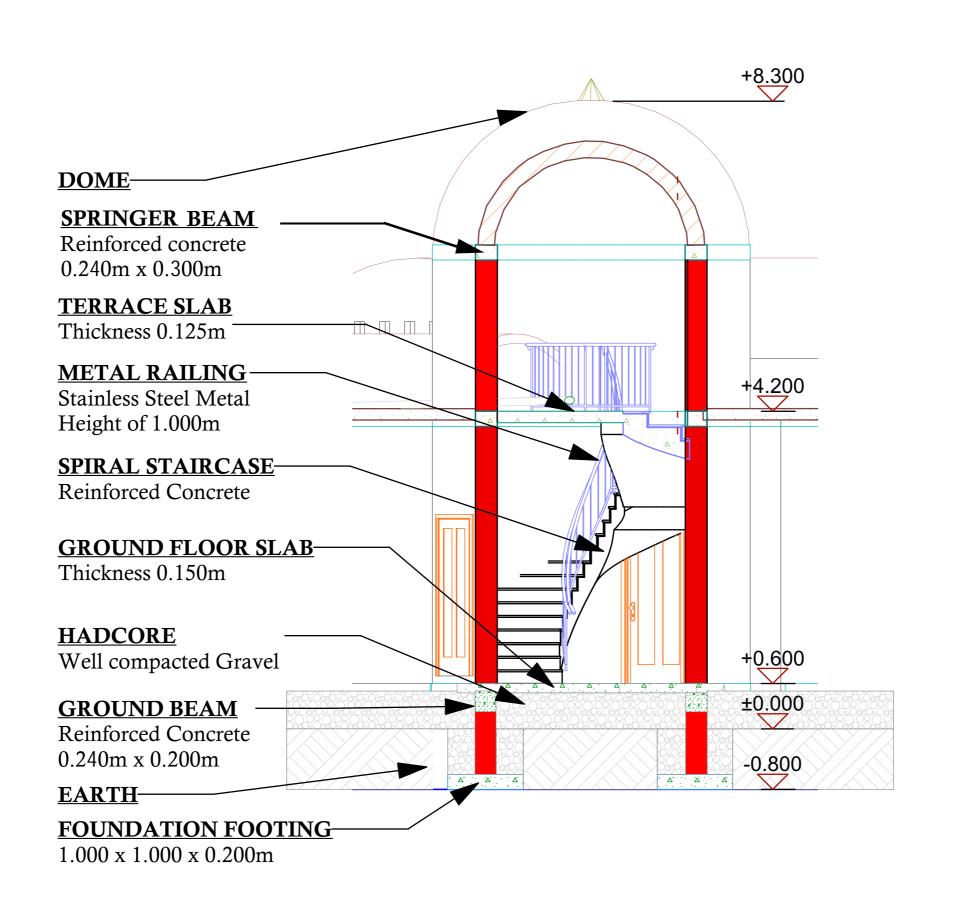
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PROJECT SITE AREA: 1000m²
Proposed Building Area: 285.448m²

DATE 5/22/2022

SCALE 1:100

A.03.5Building Section 5





GREATER BANJUL
THE GAMBIA

+220 3766269/2351601

Designed By: Structures Design

Drawn by: AH.Jow, A. O. Tamba & A. Marigo

Checked by: A.H.Jow, A. O. Tamba & A. Marigo

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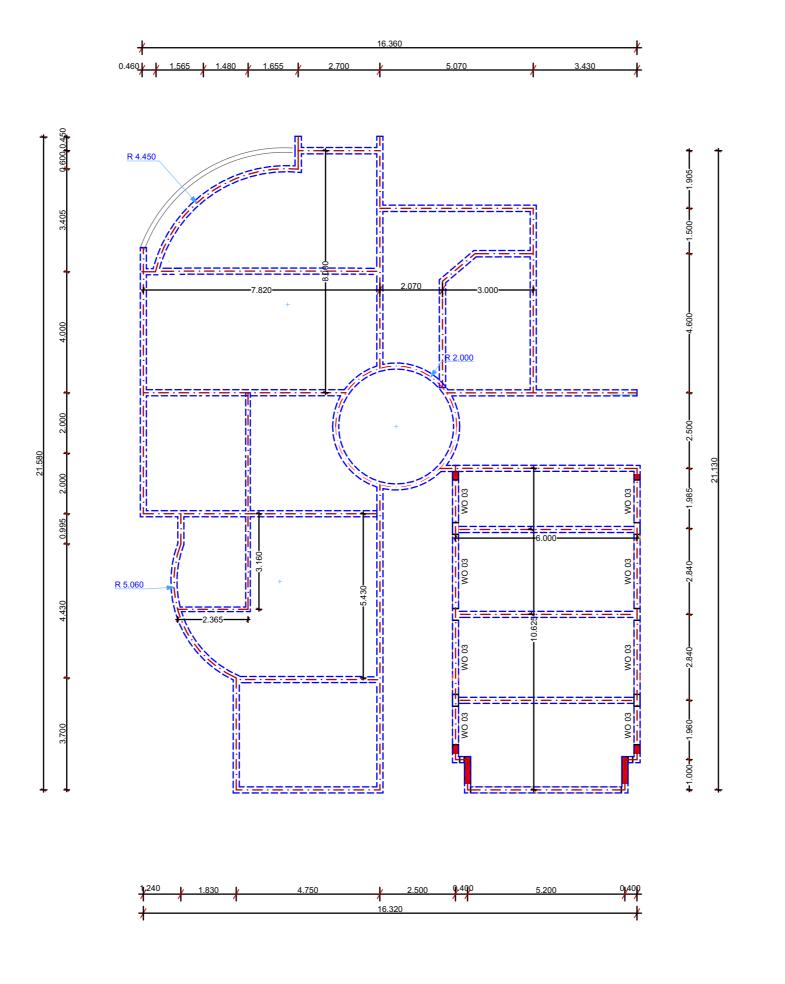
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PROJECT SITE AREA: 1000m²
Proposed Building Area: 285.448m²

DATE 5/22/2022

SCALE 1:50

A.03.6
Staircase Section





GREATER BANJUL
THE GAMBIA

+220 3766269/2351601
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Drawn by: AH.Jow, A. O. Tamba & A. Marigo
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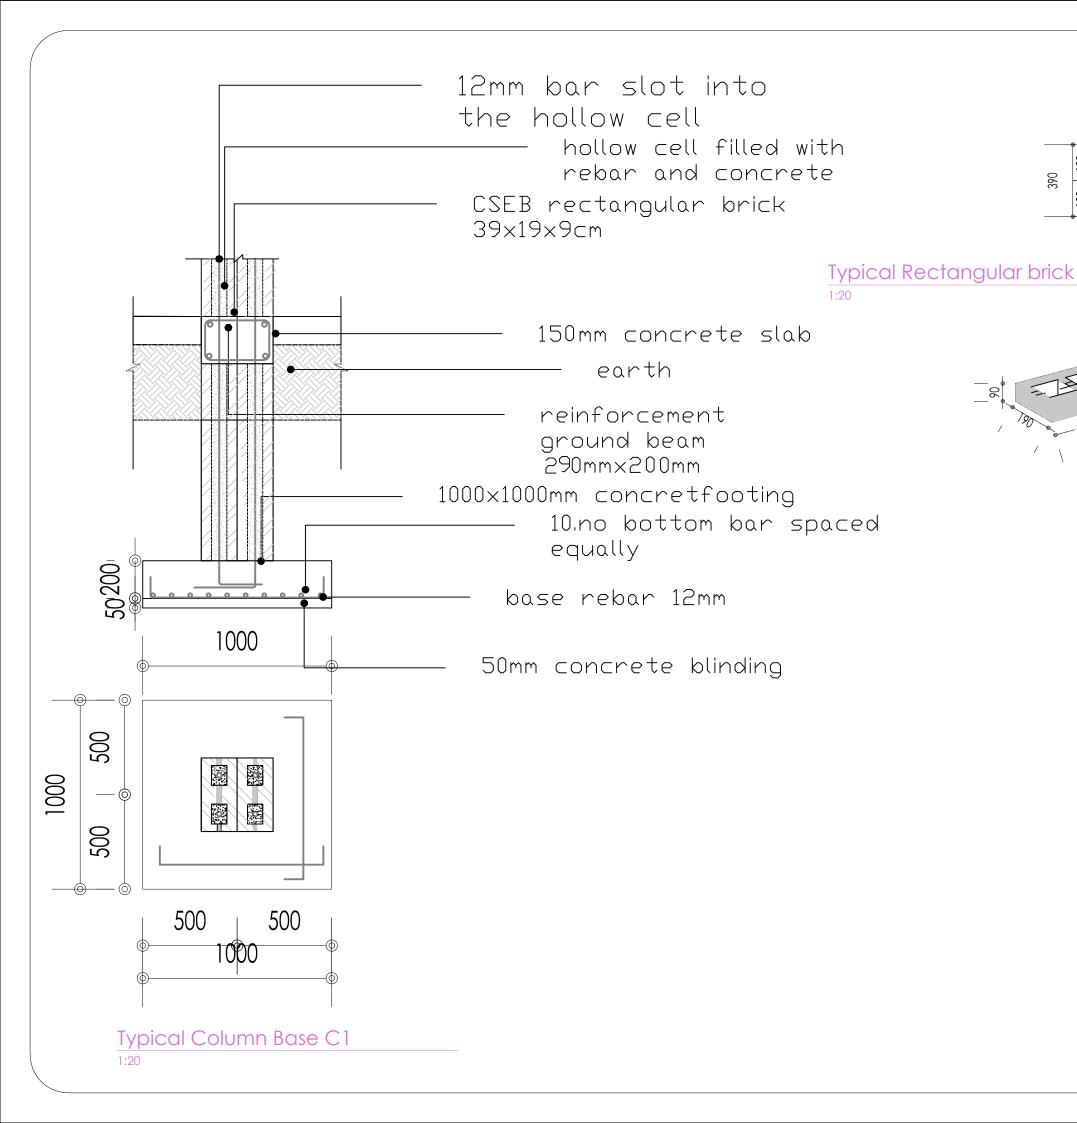
PROJECT SITE AREA: 1000m²
Proposed Building Area: 285.448m²

DATE 5/22/2022

SITE:

SCALE 1:125

A.03.7
Beam Layout





390

TOBOKOTO, KSMD

GREATER BANJUL

THE GAMBIA
+220 3766269/2351601

Designed By: STRUCTURES DESIGN

rawn by: A.Tamba,A.Marigo, A.Jow

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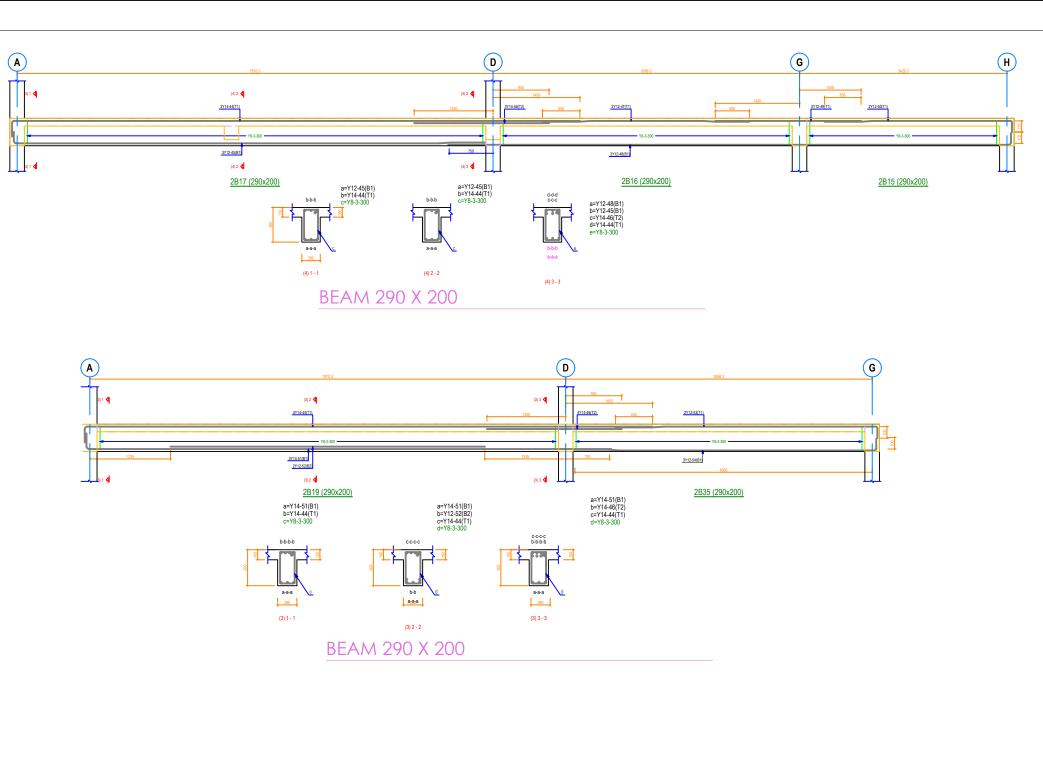
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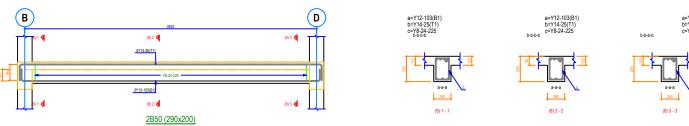
DATE 2/11/2022

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SD 01

GENERAL FOUNDATION FOOTING &COLUMN





BEAM 290 X 200



TOBOKOTO, KSMD

GREATER BANJUL

THE GAMBIA +220 3766269/2351601

Designed By : STRUCTURES DESIGN Drawn by: A.Tamba, A.Marigo, A.Jow Checked by: A.Tamba, A.Marigo, A.Jow

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Proposed Building Area: 285.448m²


DATE 2/11/2022

EARTH BUILDER'S ASSOCIATION

CLIENT:

SCALE 1:###

SD 02 R.C BEAM

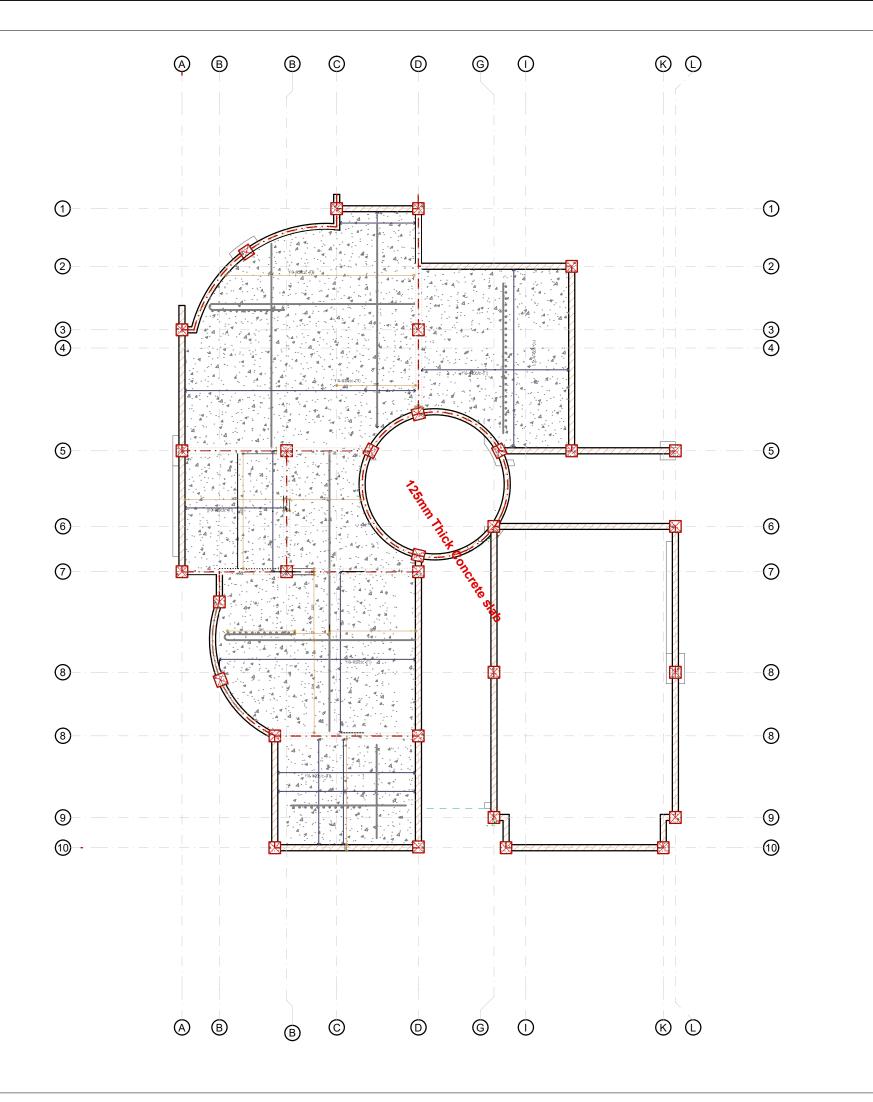



GREATER BANJUL THE GAMBIA +220 3766269/2351601

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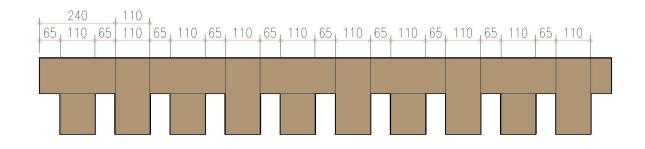
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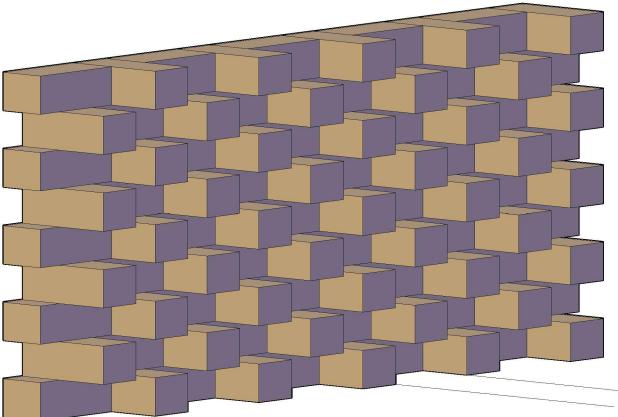
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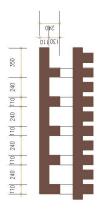
SD 03

FLOOR REINFORCEMENT WITH 10mm AT 200 CENTRES






Typical Floor Plan of Interlocging Brick




Isometric View

ViewportScale

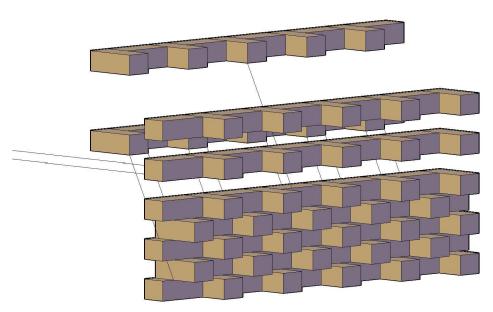

Exploded View

ViewportScale

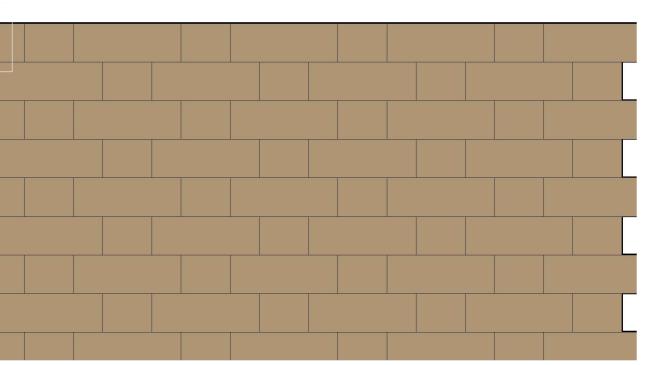

Wall Front Elevation

STRUCTURES ARCHITECTURE AND IGNOTING

TOBOKOTO, KSMD

GREATER BANJUL
THE GAMBIA

+220 3766269/2351601

Designed By #Contact Company
Drawn by: A.Tamba,A.Marigo, A.Jow
Checked by: A.Tamba,A.Marigo, A.Jow

THE INFORMATION CONTAINED HEREIN IS BELIEVED TO BE CORRECT.HOWEVER, REPORT ANY OMISSION OR ERROR TO THE DESIGNER

RevID	ChID	Change Name	Date

WESTCOAST REGION THE GAMBIA

EARTH BUILDER'S ASSOCIATION

CLIENT:

THIS DRAWING AND INFORAMA INTERPRETATION OF WHAT IS WISHES AND SPECIFICATION I

WARNING NOTE

COUNTRY:

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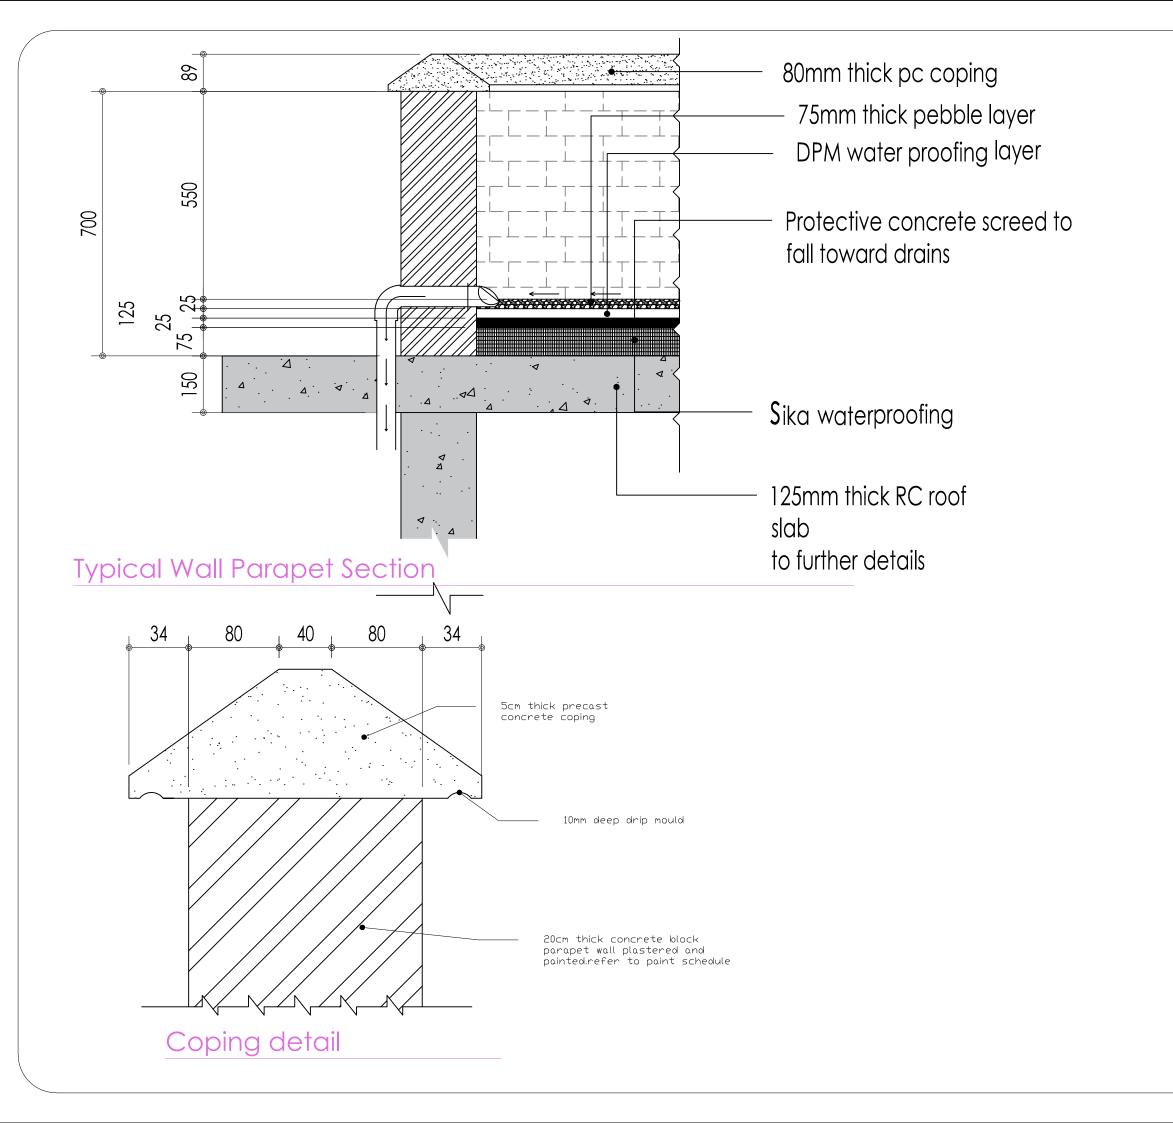
PROJECT SITE AREA: 1000m²
Proposed Building Area: 285.448m²

DATE 2/11/2022

SCALE 1:###

BW 01

FACADE DESIGN/ INTERLOCKING REC. BRICK





товокото, кѕмр

GREATER BANJUL THE GAMBIA

+220 3766269/2351601
Designed By STRUCTURES DESIGNED TRANS BY: A.Tamba, A.Marigo, A. Jow Checked by: A.Tamba, A.Marigo, A. Jow

THE INFORMATION CONTAINED HEREIN IS BELIEVED TO BE CORRECT.HOWEVER, REPORT ANY OMISSION OR ERROR TO THE DESIGNER

RevID	ChID	Change Name	Date

VESTCOAST REGION HE GAMBIA

SALAJI N: WESTO

CLIENT: EARTH BUILDER'S ASSOCIATION

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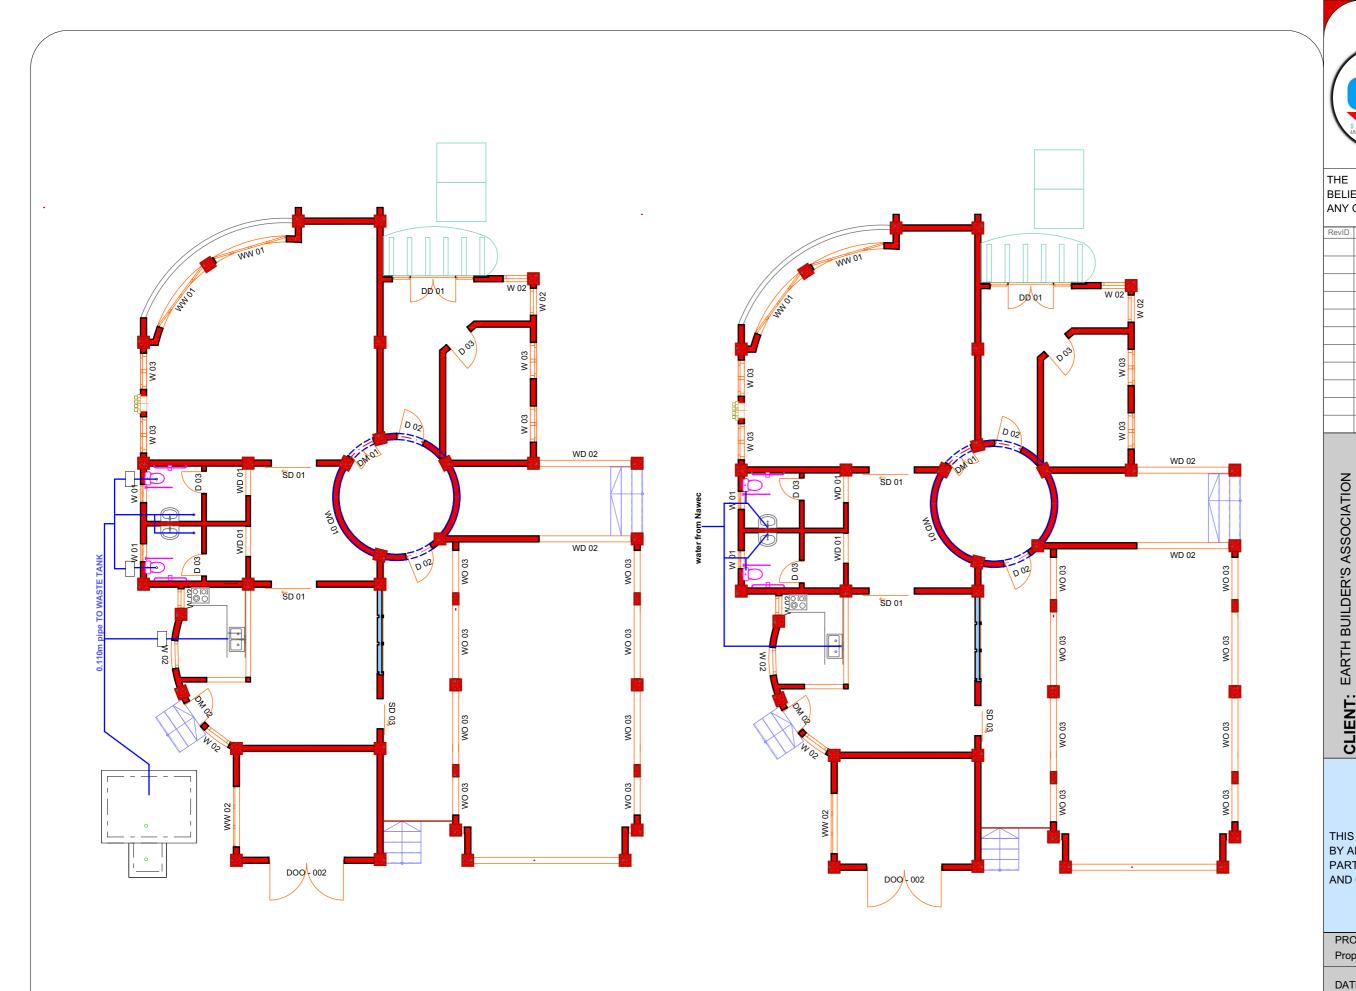
PROJECT SITE AREA: 1000m²
Proposed Building Area: 285.448m²

DATE 2/11/2022

SCALE 1:###

SD 04

Typical Wall Parapet Section





GREATER BANJUL THE GAMBIA

+220 3766269/2351601 Designed By: Structures Design Drawn by: A.H.Jow, A. O. Tamba & A. Marigo Checked by: A.H.Jow, A. O. Tamba & A. Marigo

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evID	ChID	Change Name	Date	

WESTCOAST REGION REGION: COUNTRY:

CLIENT:

WARNING NOTE

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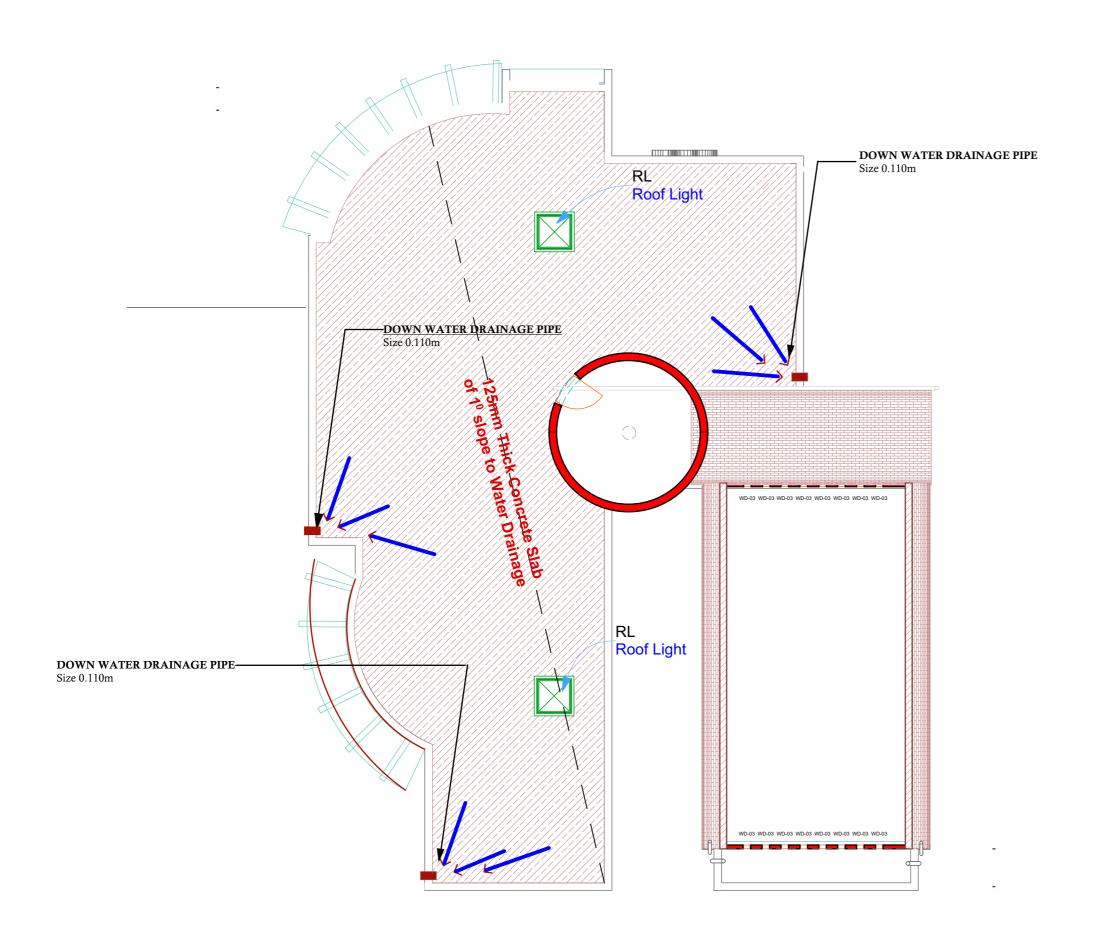
PROJECT SITE AREA: 1000m² Proposed Building Area: 285.448m²

DATE 5/22/2022

SCALE 1:125

P.01.1

Ground floor Plumbing Layout





GREATER BANJUL

THE GAMBIA +220 3766269/2351601

Designed By: Structures Design
Drawn by: A.H.Jow, A. O. Tamba & A. Marigo
Checked by: A.H.Jow, A. O. Tamba & A. Marigo

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RevID	ChID	Change Name	Date

LAJI WESTCOAST REGION THE GAMBIA

CLIENT: EARTH BUILDER'S ASSOCIATION

REGION: WES
COUNTRY: THE

WARNING NOTE

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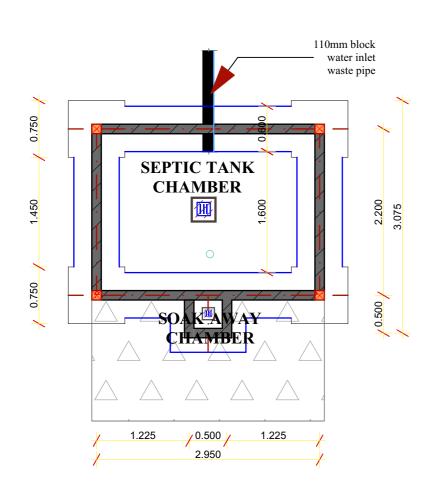
PROJECT SITE AREA: 1000m²
Proposed Building Area: 285.448m²


DATE 5/22/2022

SCALE 1:100

P.01.2

Terrace Plumbing Layout



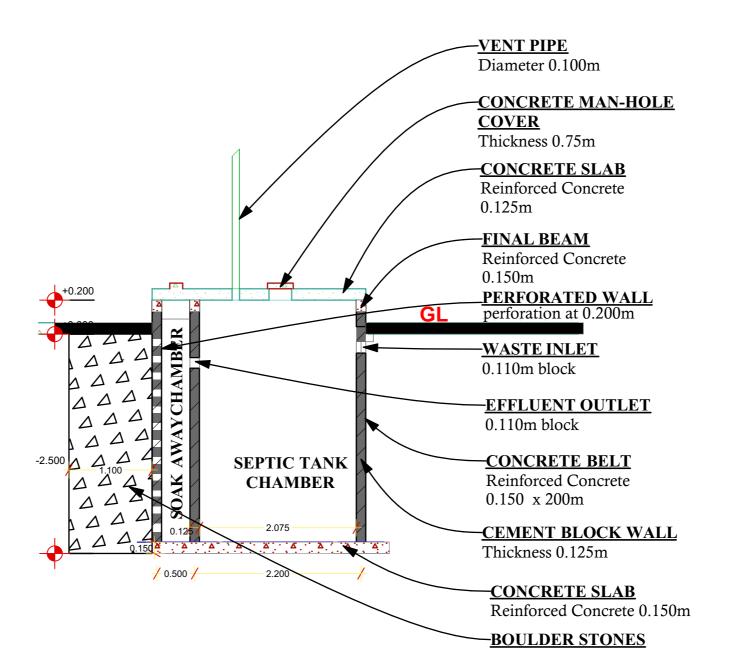



RevID ChID Change Name

TOBOKOTO, KSMD

GREATER BANJUL
THE GAMBIA

+220 3766269/2351601

Designed By: Structures Design

Drawn by: A.H.Jow, A. O. Tamba & A. Marigo

Checked by: A.H.Jow, A. O. Tamba & A. Marigo

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COUNTRY: THE GAMBIA	
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INTERPRETATION OF WHAT IS NECCESSARY TO MEET YOUR WISHES AND SPECIFICATION IN ALL FACETS OF THE BRIEF REQUIREMENTS.	
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CONFORMITY WITH THESE PARAMETER, THUS ANY FORM OF	

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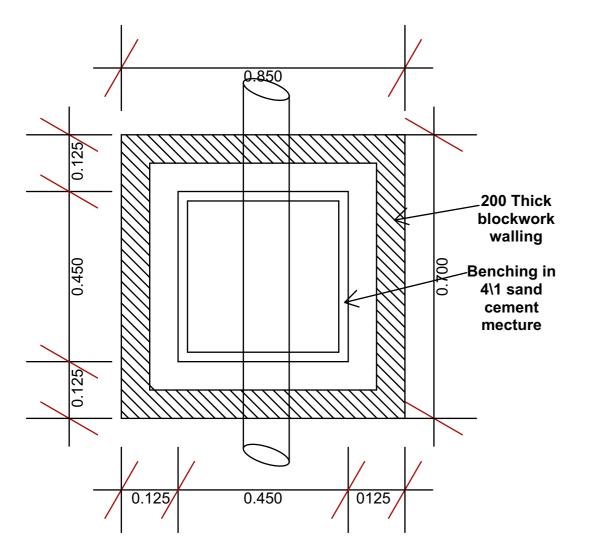
PROJECT SITE AREA: 1000m²
Proposed Building Area: 285.448m²

DATE 5/22/2022


SCALE 1:50

P.01.3

Septic Tank and Soakaway



INSPECTION CHAMBER PLAN

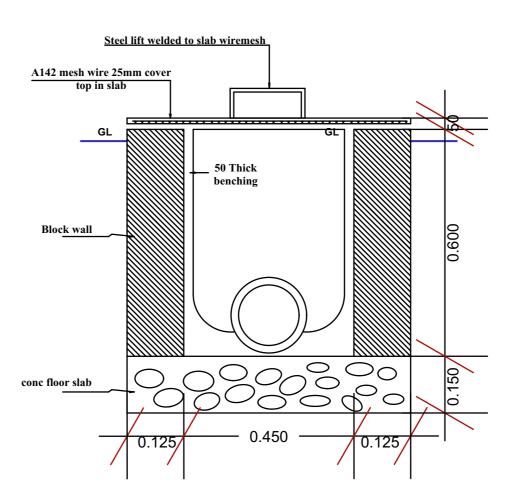

INSPECTION CHAMBER SECTION



TOBOKOTO, KSMD

GREATER BANJUL
THE GAMBIA

+220 3766269/2351601

Designed By: Structures Design

Drawn by: A.H.Jow, A. O. Tamba & A. Marigo

Checked by: A.H.Jow, A. O. Tamba & A. Marigo

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CLIENT: EAKIN BUILDER & ASSOCIATION	SITE: SALA.II	ä	COUNTRY: THE GAMBIA	THIS DRAWING AND INFORAMATION CONTAINED HEREIN IS OUR	NTERPRETATION OF WHAT IS NECCESSARY TO MEET YOUR WISHES AND SPECIFICATION IN ALL FACETS OF THE BRIEF REQUIREMENTS.	3Y YOUR APPROVAL , THEREFORE THIS DRAWING AND ITS	CONNOTATIONS HAVE BEEN FOUND/ ACCEPTED TO BE IN	CONFORMITY WITH THESE PARAMETER, THUS ANY FORM OF	MODIFICATION, INTENDED AND ADDED HEREAFTER, IS LIABLE TO	NCUR ADDITIONAL COSTS

WARNING NOTE


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PROJECT SITE AREA: 1000m²
Proposed Building Area: 285.448m²

DATE 5/22/2022

SCALE 1:10

P.01.4
Inspection Chamber



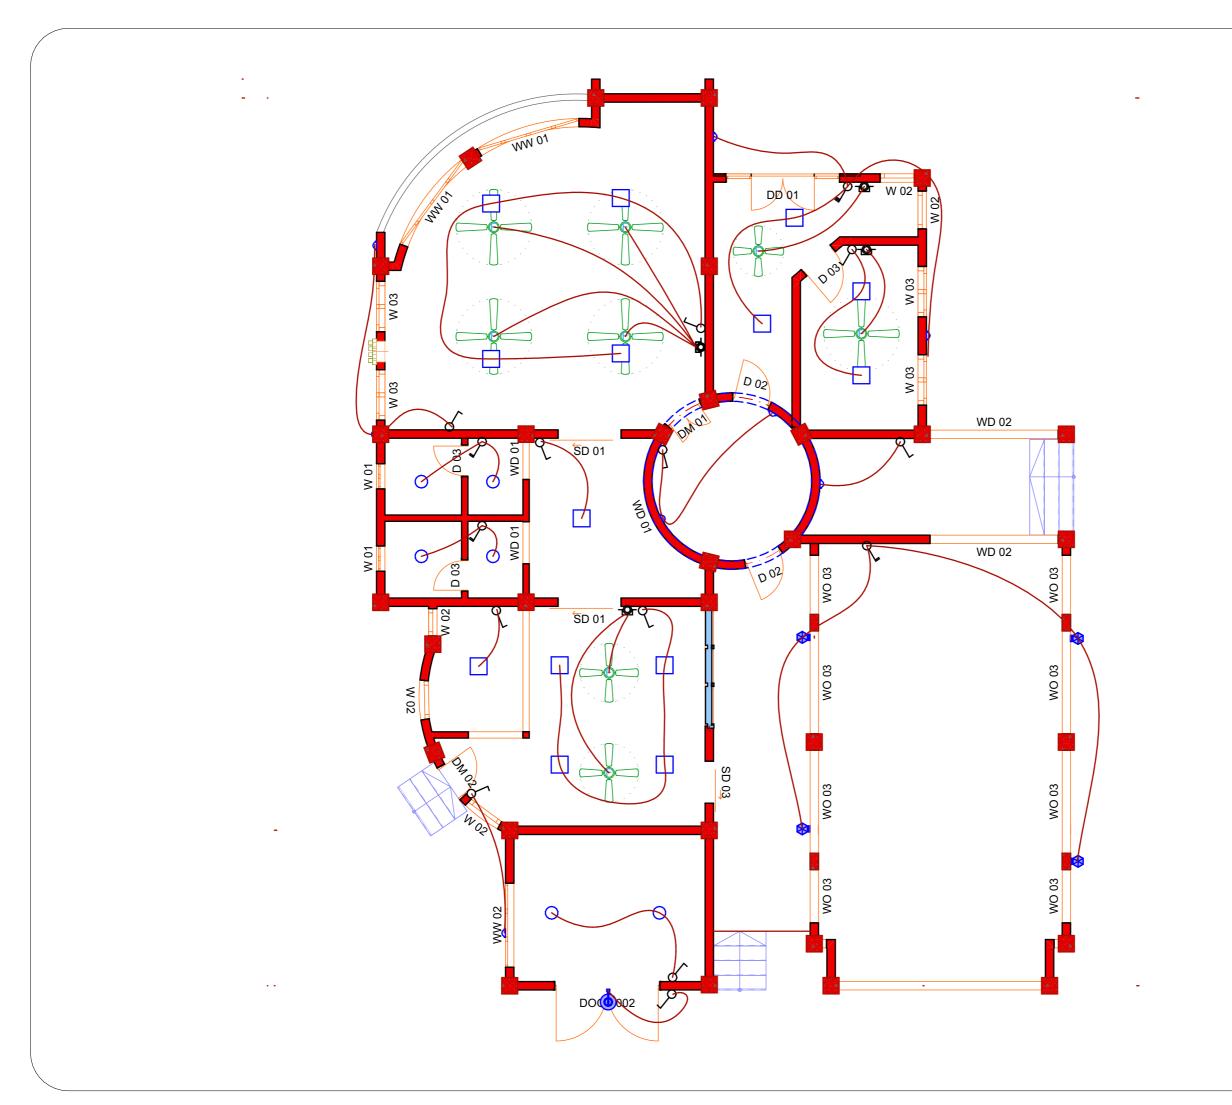

товокото, кѕмр

GREATER BANJUL

THE GAMBIA
+220 3766269/2351601
Designed By: Structures Design
Drawn by: AHJow, A. O. Tamba & A. Marigo

Checked by: A.H.Jow, A. O. Tamba & A. Marig

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LAJI WESTCOAST REGION THE GAMBIA

CLIENT: EARTH BUILDER'S ASSOCIATION

SITE: SALA REGION: W

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PROJECT SITE AREA: 1000m²
Proposed Building Area: 285.448m²

DATE 5/22/2022

SCALE 1:90

E.01.1

Ground Floor Plan Electrical Layout

Sheet Index					
Layout ID	Layout Name	Revision	Issued	Published	Remark
	Sheet Index			×	
E.04.1	Security House Foundation Plan			×	
E.04.2	Security House Floor Plan			×	
E.04.3	Security House Section			×	
E.04.4	Security House Electrical Plan La				



GREATER BANJUL
THE GAMBIA

+220 3766269/2351601

Designed By: Structures Design

Drawn by: A.H.Jow, A. O. Tamba & A. Marigo

Checked by: A.H.Jow, A. O. Tamba & A. Marigo

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RevID	ChID	Change Name	Date

WESTCOAST REGION THE GAMBIA

SALAJI

WESTCO

SITE:

CLIENT: EARTH BUILDER'S ASSOCIATION

REGION: COUNTRY:

WARNING NOTE


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PROJECT SITE AREA: 1000m²
Proposed Security House: 10.225m²

DATE 5/22/2022

SCALE 1:0.60

Sheet Index



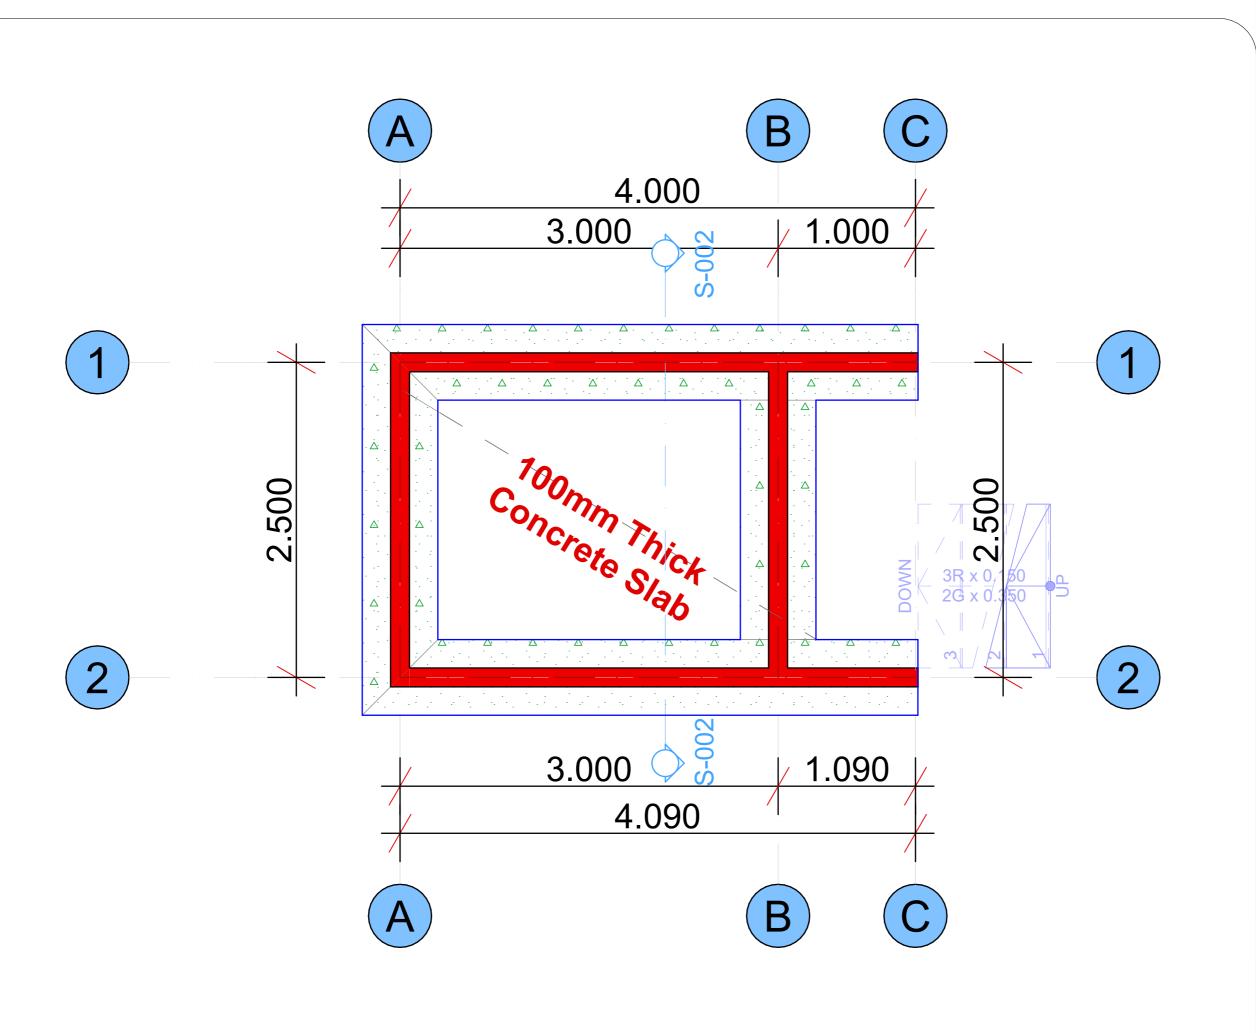

ТОВОКОТО, KSMD

GREATER BANJUL
THE GAMBIA

+220 3766269/2351601

Designed By: Structures Design

Drawn by: A.H.Jow, A. O. Tamba & A. Marigo

Checked by: A.H.Jow, A. O. Tamba & A. Marigo

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RevID	ChID	Change Name	Date	
			TS T)

WESTCOAST REGION

SITE: SALAJI
REGION: WEST

CLIENT: EARTH BUILDER'S ASSOCIATION

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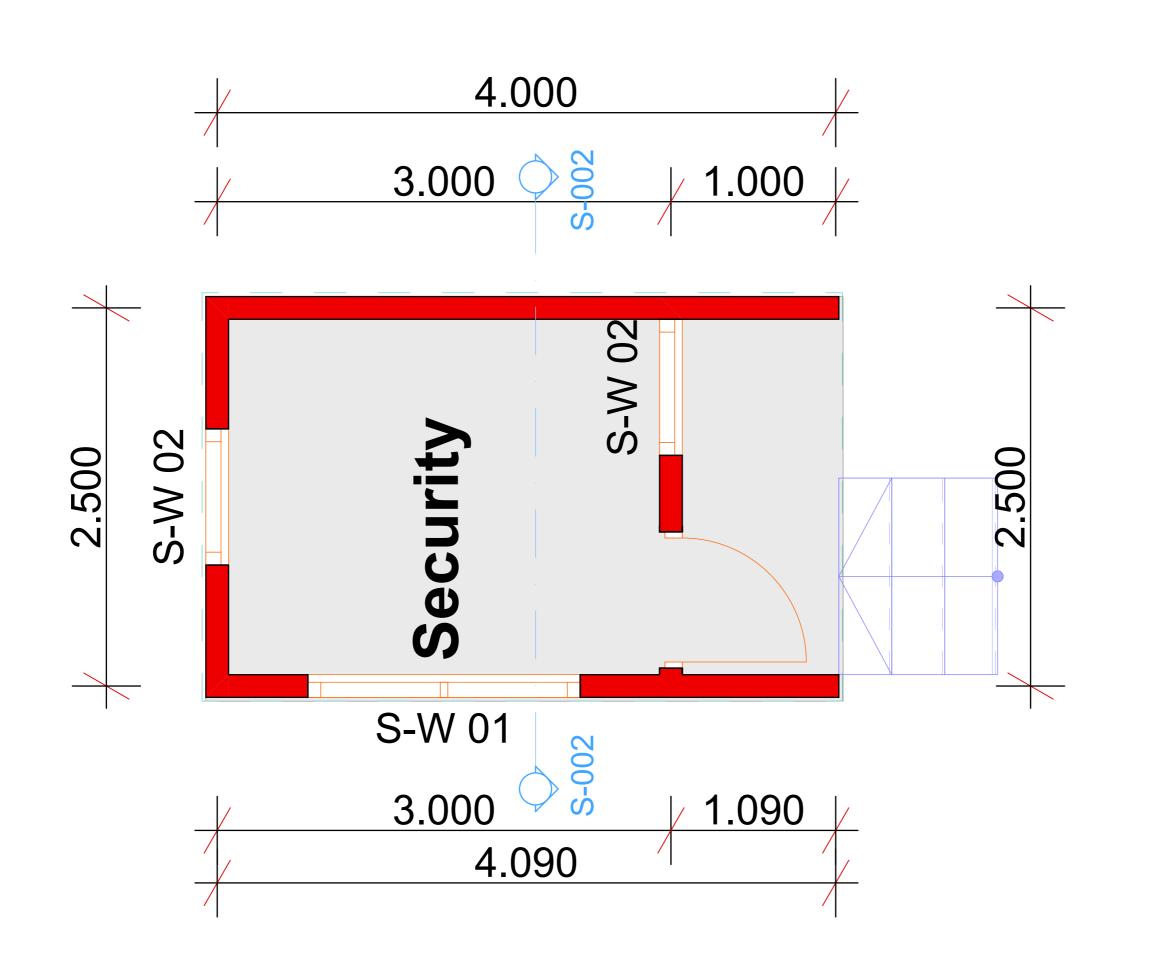
PROJECT SITE AREA: 1000m²
Proposed B Security House 10.225m²

DATE 5/22/2022

SCALE 1:30

E.04.1

Security House Foundation Plan





GREATER BANJUL
THE GAMBIA

+220 3766269/2351601

Designed By: Structures Design

Drawn by: A.H.Jow, A. O. Tamba & A. Marigo

Checked by: A.H.Jow, A. O. Tamba & A. Marigo

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RevID	ChID	Change Name	Date

WESTCOAST REGION

CLIENT: EARTH BUILDER'S ASSOCIATION

REGION: WES

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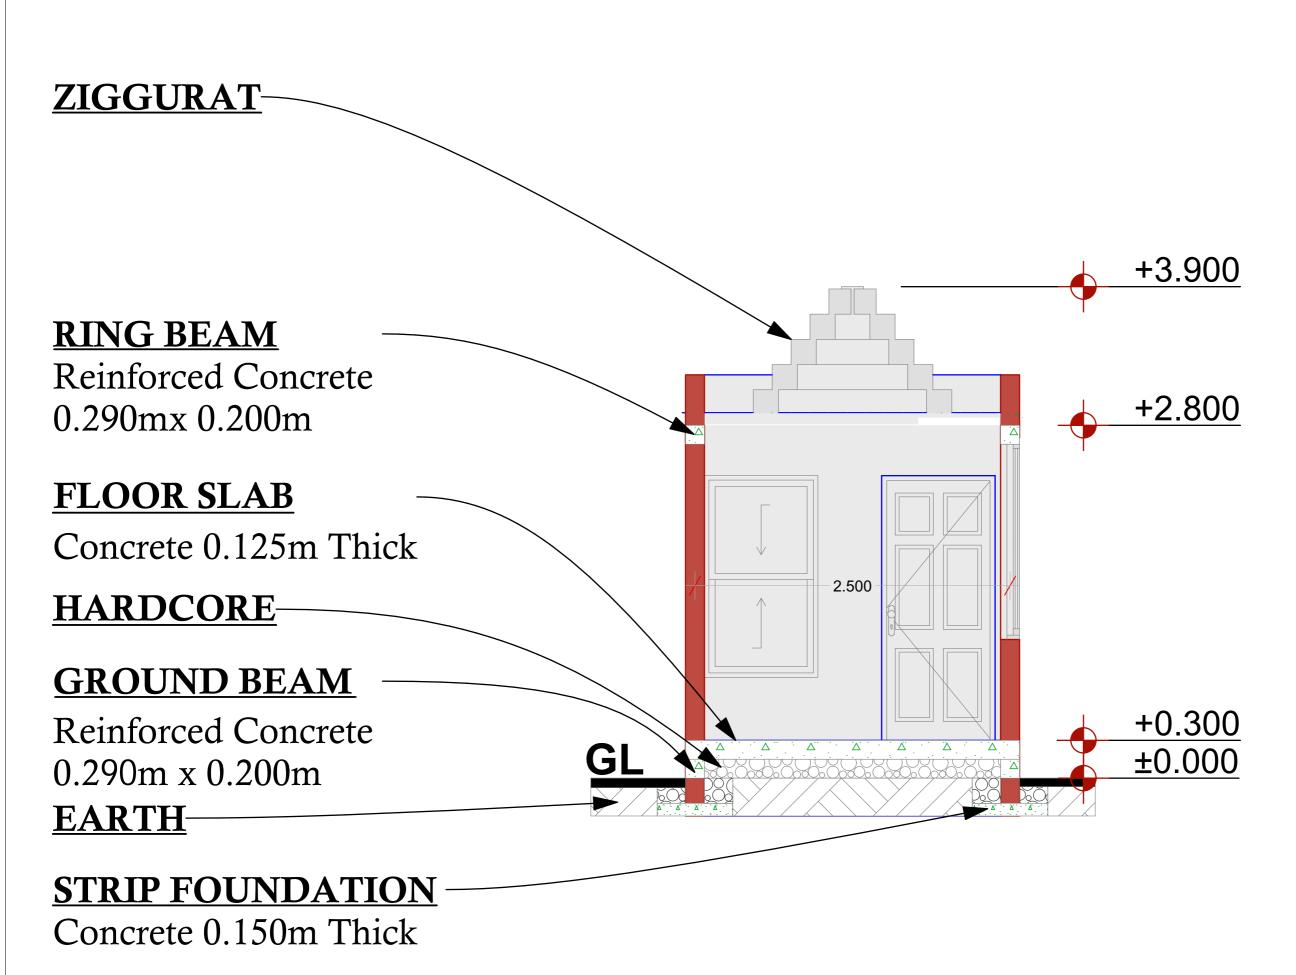
PROJECT SITE AREA: 1000m² Proposed Security House: 10.225m²

DATE 5/22/2022

SCALE 1:25

E.04.2

Security House Floor Plan





GREATER BANJUL
THE GAMBIA

+220 3766269/2351601

Designed By: Structures Design

Drawn by: A.H.Jow, A. O. Tamba & A. Marigo

Checked by: A.H.Jow, A. O. Tamba & A. Mar

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EARTH BUILDER'S ASSOCIATION				
SALAJI				
WESTCOAST REGION				

WARNING NOTE

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PROJECT SITE AREA: 1000m²
Proposed Security House 10.225m²


DATE 5/22/2022

SCALE 1:30

E.04.3

Security House Section



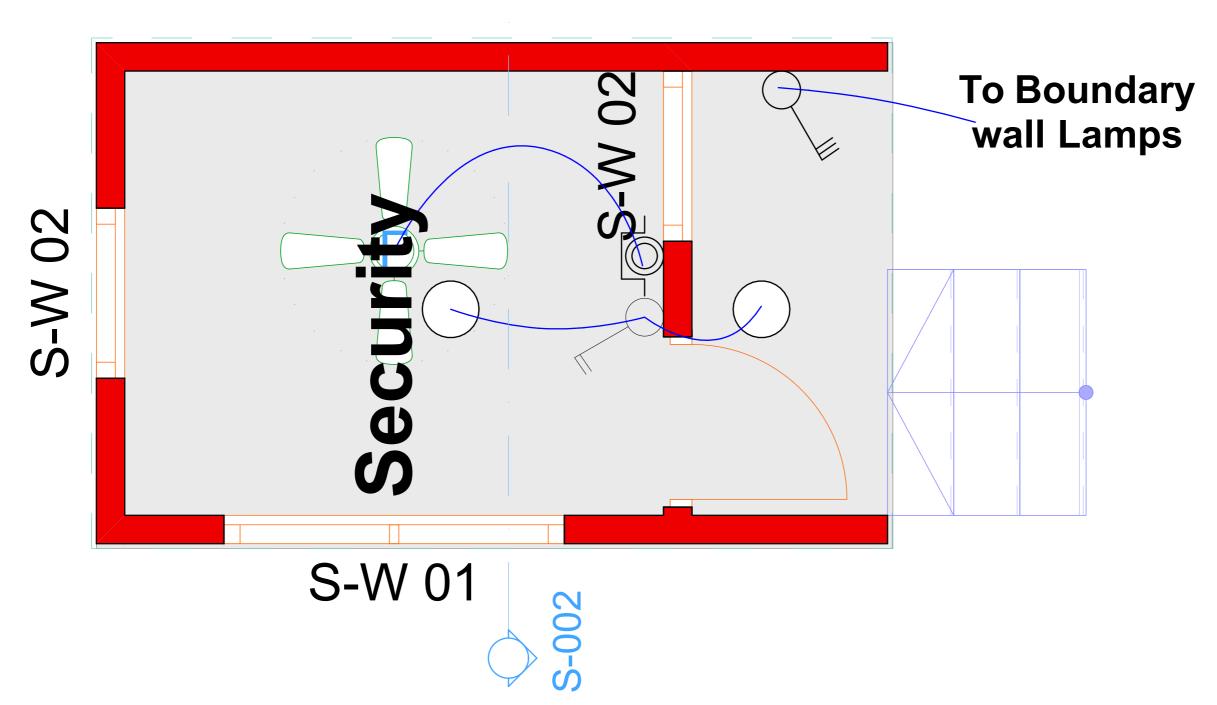



GREATER BANJUL THE GAMBIA

+220 3766269/2351601 Designed By: Structures Design Drawn by: A.H.Jow, A. O. Tamba & A. Marigo Checked by: A.H.Jow, A. O. Tamba & A. Marig

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CLIENT: EARTH B	SITE: SALA ::	i NO	COUNTRY: THE GAMBIA	THIS DRAWING AND INFO	NTERPRETATION OF WHAT	AND SPECIFICATION IN ALL F	3Y YOUR APPROVAL ,	CONNOTATIONS HAVE BI	CONFORMITY WITH THESI	MODIFICATION, INTENDED

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PROJECT SITE AREA: 1000m² Proposed Security House: 10.225m²

5/22/2022

SCALE 1:20

E.04.4

Security House Electrical Plan Layout

Outside Toil	et Sheet Index				
Layout ID	Layout Name	Revision	Issued	Published	Remark
	Sheet Index			×	
A.05.1	Outside Toilet Plan			×	
A.05.2	Outside Toilet Section S-001			×	
A.05.3	Outside Toilet Elctrical			×	
A.05.4	Outside Toilet Plumbing Waste			×	
A.05.5	Outside Toilet Water Supply			×	
A.05.6	Outside Toilet Foundation				



товокото, кѕмр

GREATER BANJUL
THE GAMBIA

+220 3766269/2117014

Designed By: Structures Design

Drawn by: A.H.Jow, A. O. Tamba & A. Marigo

Checked by: A.H.Jow, A. O. Tamba & A. Marigo

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RevID	ChID	Change Name	Date

WESTCOAST REGION THE GAMBIA

REGION: WESTCC COUNTRY: THE GAN

SALAJI

SITE:

CLIENT: EARTH BUILDER'S ASSOCIATION

WARNING NOTE


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PROJECT SITE AREA: 1000m²
Proposed Building Area: 6m²

DATE 5/11/2022

SCALE 1:0.60

Sheet Index



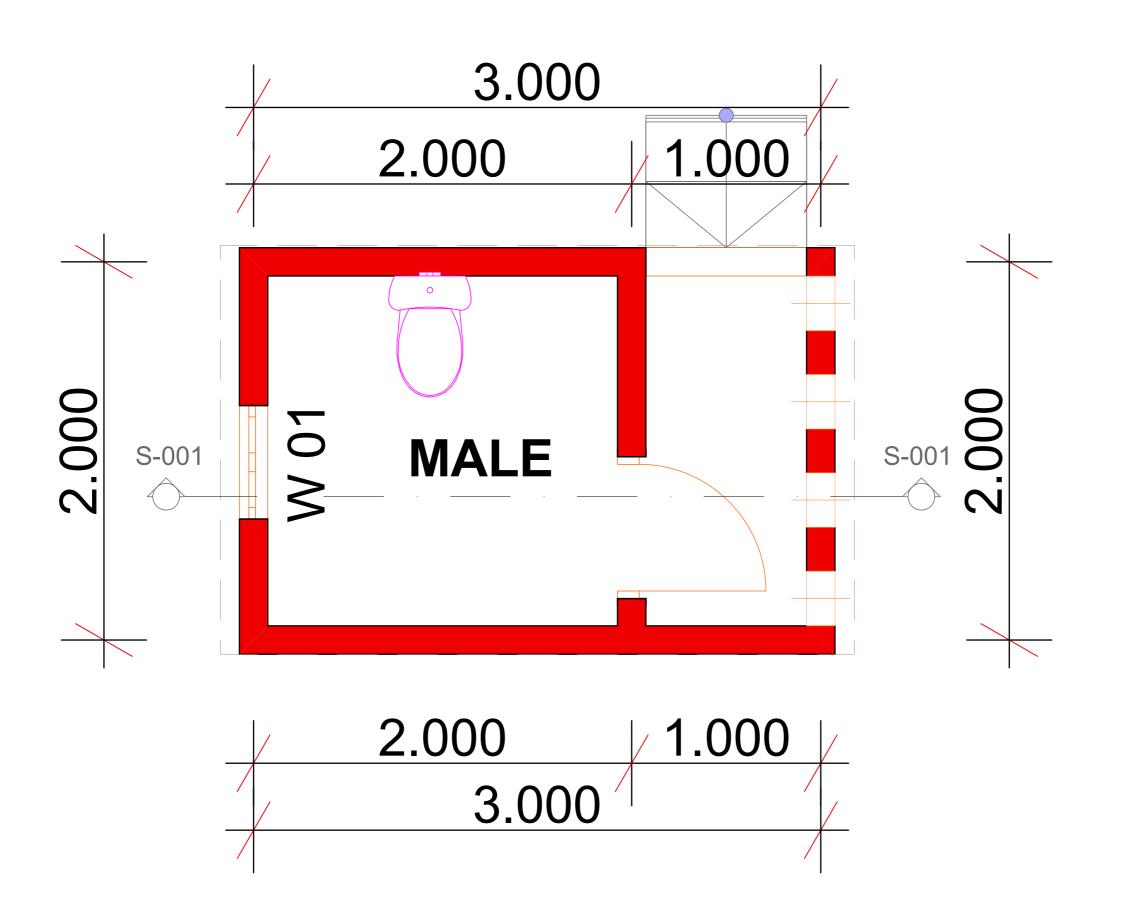

товокото, кѕмр

GREATER BANJUL
THE GAMBIA

+220 3766269/2117014

Designed By: Structures Design

Drawn by: A.H.Jow, A. O. Tamba & A. Marigo

Checked by: A.H.Jow, A. O. Tamba & A. Marigo

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RevID	ChID	Change Name	Date
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STCOAST REGION F GAMBIA

N: WESTCO

CLIENT: EARTH BUILDER'S ASSOCIATION

WARNING NOTE


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PROJECT SITE AREA: 1000m²
Proposed Outside Toilet: 6m²

DATE 5/11/2022

SCALE 1:20

A.05.1Outside Toilet Plan



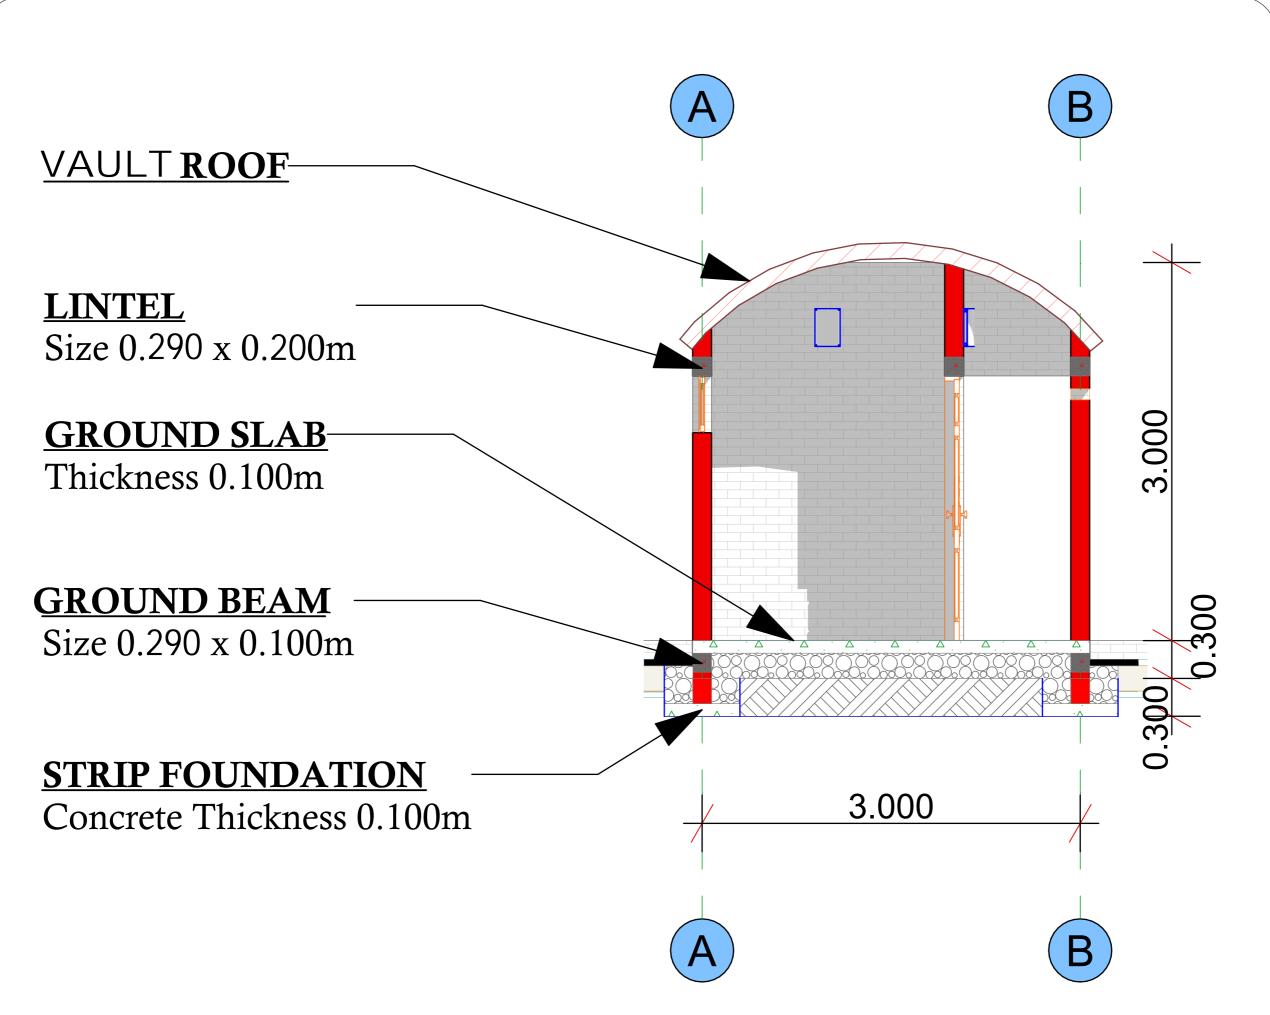

GREATER BANJUL
THE GAMBIA

+220 3766269/2117014

Designed By: Structures Design

Drawn by: A.H.Jow, A. O. Tamba & A. Marigo

Checked by: A.H.Jow, A. O. Tamba & A. Mar

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EARTH BUILDER'S ASSOCIATION				
SALAJI		+		
WESTCOAST REGION				

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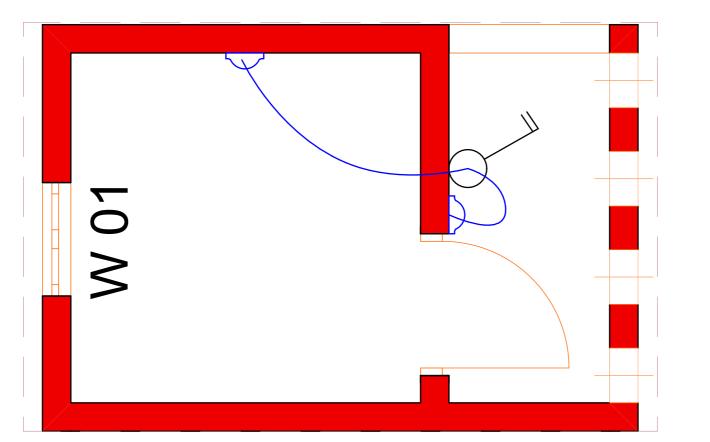
PROJECT SITE AREA: 1000m²
Proposed Outside Toilet: 6m²

DATE 5/11/2022

SCALE 1:30

A.05.2

Outside Toilet Section S-001





GREATER BANJUL THE GAMBIA

+220 3766269/2117014 Designed By: Structures Design Drawn by: A.H.Jow, A. O. Tamba & A. Marigo Checked by: A.H.Jow, A. O. Tamba & A. Marigo

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WESTCOAST REGION

SITE:

CLIENT: EARTH BUILDER'S ASSOCIATION

REGION: COUNTRY:

WARNING NOTE


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PROJECT SITE AREA: 1000m² Proposed Outside Toilet: 6m²

DATE 5/11/2022

SCALE 1:20

A.05.3 **Outside Toilet Elctrical**



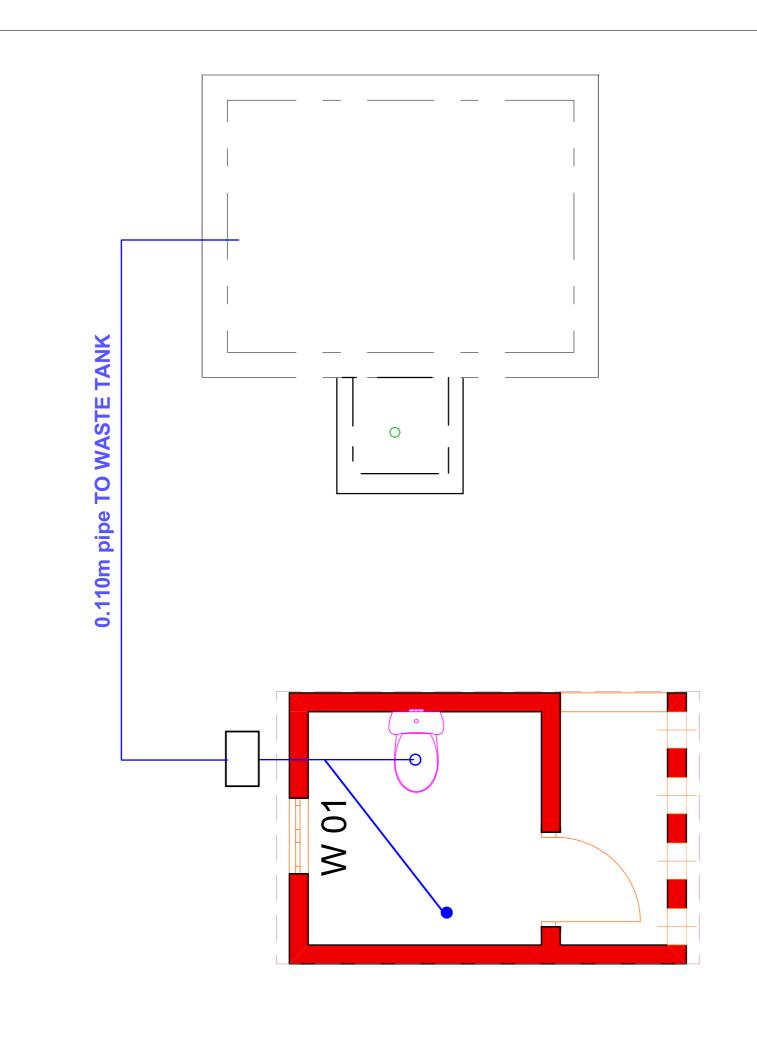

товокото, кѕмр

GREATER BANJUL

THE GAMBIA

+220 3766269/2117014

Designed By: Structures Design

Drawn by: A.H.Jow, A. O. Tamba & A. Marigo

Checked by: A.H.Jow, A. O. Tamba & A. Marigo

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RevID	ChID	Change Name	Date

a.

WESTCOAST REGION

': THE GAMBIA

REGION: WE COUNTRY: TH

CLIENT: EARTH BUILDER'S ASSOCIATION

WARNING NOTE

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PROJECT SITE AREA: 1000m² Proposed Outside Toilet: 6m²


DATE 5/11/2022

SCALE 1:30

A.05.4

Outside Toilet Plumbing Waste

water from Nawec

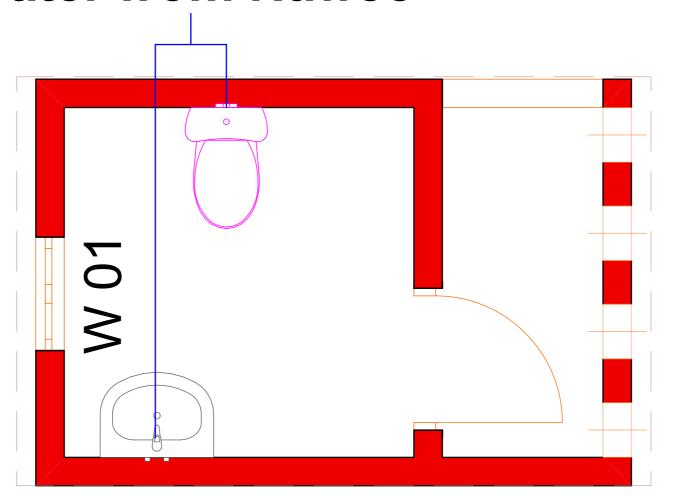



TOBOKOTO, KSMD

GREATER BANJUL
THE GAMBIA

+220 3766269/2117014

Designed By: Structures Design

Drawn by: A.H.Jow, A. O. Tamba & A. Marigo

Checked by: A.H.Jow, A. O. Tamba & A. Marigo

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RevID	ChID	Change Name		Date

VESTCOAST REGION THE GAMBIA

CLIENT: EARTH BUILDER'S ASSOCIATION

IE: SALAU EGION: WE OUNTRY: THE

WARNING NOTE

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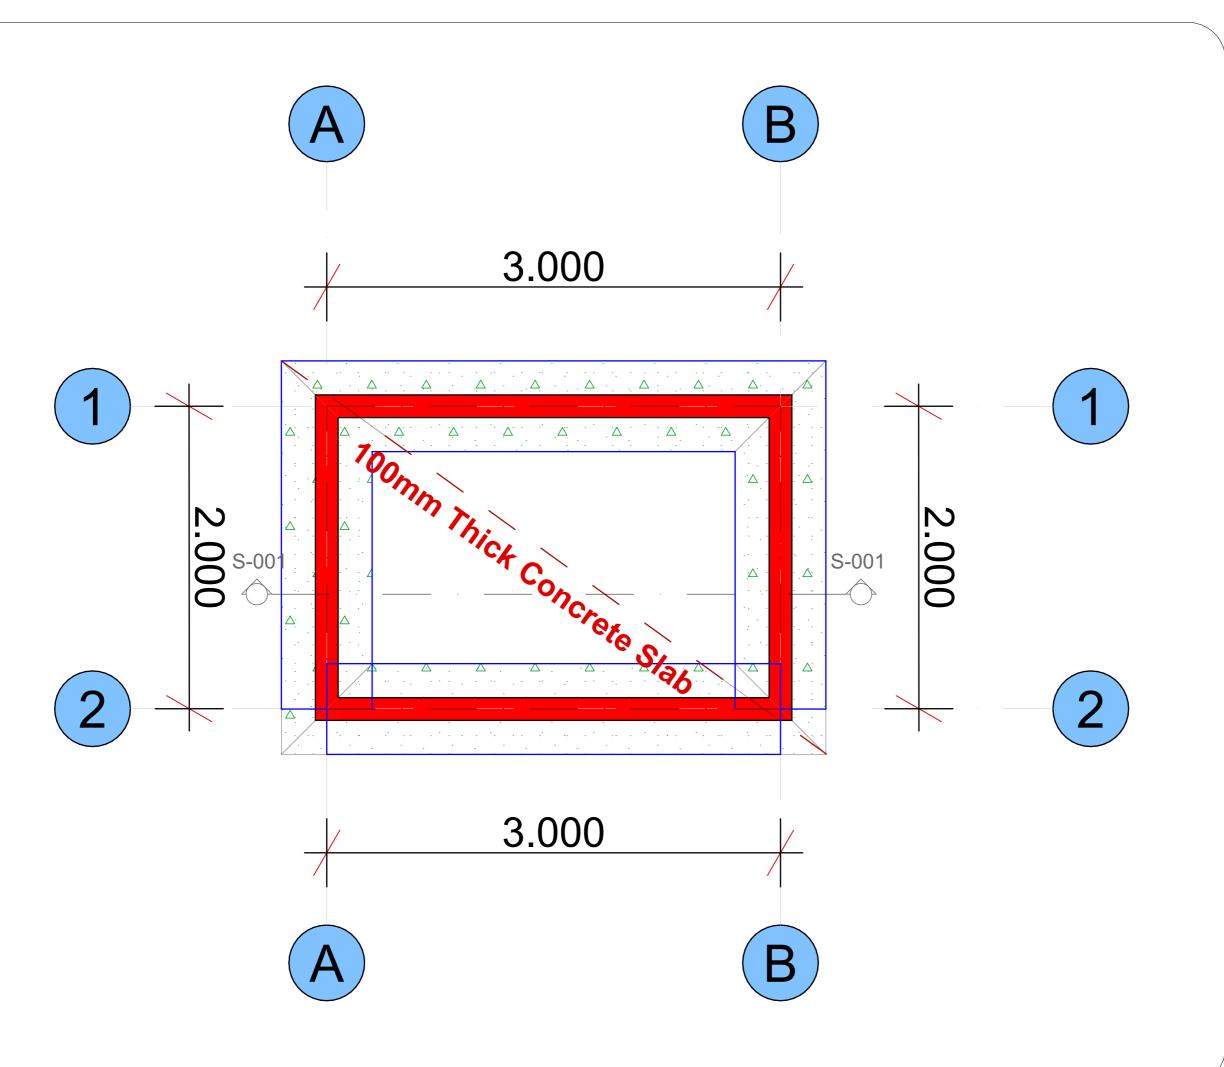
PROJECT SITE AREA: 1000m²
Proposed Outside Toilet: 6m²

DATE 5/11/2022

SCALE 1:20

A.05.5

Outside Toilet Water Supply





GREATER BANJUL
THE GAMBIA

+220 3766269/2117014

Designed By: Structures Design

Drawn by: A.H.Jow, A. O. Tamba & A. Marigo

Checked by: A.H.Jow, A. O. Tamba & A. Marigo

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RevID	ChID	Change Name	Date
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WESTCOAST REGION THE GAMBIA

SILE: SALAJI
REGION: WEST

CLIENT: EARTH BUILDER'S ASSOCIATION

WARNING NOTE

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PROJECT SITE AREA: 1000m²
ProposedOutside Toilet: 6m²

DATE 5/11/2022

SCALE 1:25

A.05.6

Outside Toilet Foundation

					Door Schedule					
Element ID	D 02	D 02	D 03	D 03	DD 01	DM 00	DM 01	DM 02	DOO - 002	M_Single-Flush:076
Quantity	1	1	1	2	1	1	1	1	1	1
ID by Classification	Door -D 02	Door -D 02	Door -D 03	Door -D 03	Door -DD 01	Door -DM 00	Door -DM 01	Door -DM 02	Door - 002	Door -Flush:0762 x
W x H Size	0.900×2.100	0.900×2.100	0.900×2.100	0.750×2.100	2.700×2.500	1.500×2.100	0.902×2.100	0.900×2.100	2.500×2.500	0.900×2.000
Sill height	0.000	0.100	0.000	0.000	0.000	0.000	0.000	0.100	0.000	0.000
Head height	2.100	2.200	2.100	2.100	2.500	2.100	2.100	2.200	2.500	2.000
2D Symbol										
3D Back View										

	Door Schedule	
Element ID	SD 01	SD 03
Quantity	2	1
ID by Classification	Door -SD 01	Door -SD 03
W x H Size	1.500×2.100	1.000×2.100
Sill height	0.000	0.000
Head height	2.100	2.100
2D Symbol		
3D Back View		



товокото, кѕмр

GREATER BANJUL
THE GAMBIA

+220 3766269/2351601

Designed By: Structures Design

Drawn by: A.H.Jow, A. O. Tamba & A. Marigo

Checked by: A.H.Jow, A. O. Tamba & A. Marigo

THE INFORMATION CONTAINED HEREIN IS BELIEVED TO BE CORRECT.HOWEVER, REPORT ANY OMISSION OR ERROR TO Structures Design

RevID	ChID	Change Name	Date

WESTCOAST REGION
THE GAMBIA

CLIENT: EARTH BUILDER'S ASSOCIATION

SITE: SALAJI
REGION: WEST
COUNTRY: THE G

WARNING NOTE

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PROJECT SITE AREA: 1000m²
Proposed Building Area: 285.448m²

DATE 5/22/2022

SCALE 1:1

S.01.1
Door Schedule

							W:	ndow Schedule							
	1						VVII	ndow Schedule	ı						
Name										Circular Empty Ope	Circular Empty Opening	Fixed Window	Horizontal Multi-sash Window	Horizontal Multi-Sash Window	Multi-Hung WIndow
ID	W 01	W 02	W 02	W 03	WD-03	WD - 004	WO 03	WO 03	WO 03	WD 02	WD 02	WD-03	WW 01	WW 01	WW 02
Quantity	2	1	4	4	8	1	2	2	4	1	2	8	1	1	1
W x H Size	0.600×0.450	0.650×1.800	0.900×1.800	1.200×1.800	0.200×1.000	0.150×0.200	1.270×2.500	1.410×2.500	2.450×2.500	2.710×2.800	3.048×2.500	0.200×1.000	2.500×0.500	2.500×0.500	2.000×0.500
Head height	2.100	2.150	2.150	2.150	1.185	3.350	2.500	2.500	2.500	2.575	2.400	1.185	2.800	2.800	2.100
Sill height	1.650	0.350	0.350	0.350	0.185	3.150	0.000	0.000	0.000	-0.225	-0.100	0.185	2.300	2.300	1.600
Home Story Name	Ground Floor	Ground Floor	Ground Floor	Ground Floor	Terrace/Root	Ground Floor	Ground Floor	Ground Floor	Ground Floor	Ground Floor	Ground Floor	Terrace/Roof	Ground Floor	Ground Floor	Ground Floor
2D Symbol		==		- - 	=	=				=		=			<u> </u>
3D Back View		1	1												
				1	Vindow Schedule										
Name	Rectangular Empty	Rectangular Empty O	pening Rectangular E	mpty Rectangular	Empty Opening	Rectangular Empty Opening	Rectangular Empty Op	pe Roof Light 0	Glass Doom Ro	of Lignt Glass Doom					
ID	WD 01	WD - 001	WD - 00	04 WI	0 - 004	WD - 016	WD - 016	R	L	RL					

				Window Schedul	e			
Name	Rectangular Empty	Rectangular Empty Opening	Rectangular Empty	Rectangular Empty Opening	Rectangular Empty Opening	Rectangular Empty Ope	Roof Light Glass Doom	Roof Light Glass Doom
ID	WD 01	WD - 001	WD - 004	WD - 004	WD - 016	WD - 016	RL	RL
Quantity	3	1	1	1	1	1	1	1
W x H Size	1.000×2.500	4.982×2.500	0.150×0.200	2.849×1.900	1.300×2.500	2.981×1.500		
Head height	2.500	2.500	3.350	2.200	2.500	2.500		
Sill height	0.000	0.000	3.150	0.300	0.000	1.000		
Home Story Name	Ground Floor	Ground Floor	Ground Floor	Ground Floor	Ground Floor	Ground Floor	Terrace/Roof	Terrace/Roof
2D Symbol	_		= = =					
3D Back View								



GREATER BANJUL THE GAMBIA

+220 3766269/2351601 Designed By: Structures Design Drawn by: A.H.Jow, A. O. Tamba & A. Marigo Checked by: A.H.Jow, A. O. Tamba & A. Marigo

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				JUR	HES .	STI	OF	10	
CLIENT: EARTH BUILDER'S ASSOCIATION	SITE: SALA.II	ä	COUNTRY: THE GAMBIA	THIS DRAWING AND INFORAMATION CONTAINED HEREIN IS OUR	INTERPRETATION OF WHAT IS NECCESSARY TO MEET YOUR WISHES AND SPECIFICATION IN ALL FACETS OF THE BRIEF REQUIREMENTS.	BY YOUR APPROVAL , THEREFORE THIS DRAWING AND ITS CONNOTATIONS HAVE BEEN FOUND/ ACCEPTED TO BE IN	CONFORMITY WITH THESE PARAMETER, THUS ANY FORM OF	MODIFICATION, INTENDED AND ADDED HEREAFTER, IS LIABLE TO	ST300 INDITION OF THE

SITE: SALAJI REGION: WESTCC COUNTRY: THE GAI

WARNING NOTE

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PROJECT SITE AREA: 1000m² Proposed Building Area: 285.448m²

DATE 5/22/2022

SCALE 1:1.50

S.01.2 window schedule

		Wall So					
Element ID	2D Plan Preview	Wall Type	Height [m]	Thickness [m]	Area [m2]	Perimeter [m]	Home Story Name
Basic Wall:wall exteri	<u> </u>	ex. wall brick	0.600	0.20	0.08	1.15	Level 1
Basic Wall:wall exteri		ex. wall brick	0.700	0.20	0.58	6.68	Terrace/Roof
Basic Wall:wall exteri		ex. wall brick	0.700	0.20	0.15	1.75	Terrace/Roof
Basic Wall:wall exteri		ex. wall brick	0.700	0.20	1.27	13.20	Terrace/Roof
Basic Wall:wall exteri		ex. wall brick	0.700	0.20	0.08	1.34	Terrace/Roof
Basic Wall:wall exteri		ex. wall brick	0.700	0.20	1.60	16.56	Terrace/Roof
Basic Wall:wall exteri		ex. wall brick	0.150	0.15	0.14	2.11	Level 1
Basic Wall:wall exteri Basic Wall:wall exteri		ex. wall brick ex. wall brick	0.150	0.15	0.67	9.37 7.00	Level 1
Basic Wall:wall exteri			0.150			37.46	
Basic Wall-wall exteri		ex. wall brick ex. wall brick	0.150	0.15	2.80	9.08	Level 1
Basic Wall:wall exteri		ex. wall brick	0.600	0.15	0.60	9.08	Level 1
Basic Wall:wall exteri	_=_	ex. wall brick	0.600	0.15	0.31	6.05	Level 1
Basic Wall-wall exteri		ex. wall brick	2 000	0.15	1.26	12.97	Terrace/Roof
Basic Wall:wall exteri		ex. wall brick	2.000	0.20	1.07	12.97	Terrace/Roof
Basic Wall:wall exteri		Masonry Block - Stru	0.800	0.20	0.46	5.60	FOUNDATION
Basic Wall:wall exteri	777	Masonry Block - Stru	0.800	0.20	3.30	38.65	FOUNDATION
Basic Wall:wall exteri		Masonry Block - Stru	0.800	0.20	1.21	14.26	FOUNDATION
Basic Wall:wall exteri	777	Masonry Block - Stru	0.800	0.20	1.64	18.08	FOUNDATION
Basic Wall:wall exteri	7//	Masonry Block - Stru	0.800	0.20	1.10	13.00	FOUNDATION
Basic Wall:wall exteri	7777	Masonry Block - Stru	0.800	0.20	1.09	12.95	FOUNDATION
Basic Wall:wall exteri	777	Masonry Block - Stru	1.050	0.20	1.20	13.60	FOUNDATION
Basic Wall:wall exteri	7773	Masonry Block - Stru	0.800	0.20	2.24	26.15	FOUNDATION
Basic Wall:wall exteri	7777	Masonry Block - Stru	0.800	0.20	0.96	10.42	FOUNDATION
Basic Wall:wall exteri	777	Masonry Block - Stru	0.800	0.20	2.51	28.78	FOUNDATION
Basic Wall:wall exteri	7777	Masonry Block - Stru	0.800	0.20	0.14	2.57	FOUNDATION
Basic Wall:wall exteri	777	Masonry Block - Stru	0.800	0.20	0.96	10.97	FOUNDATION
Basic Wall:wall exteri	777	Masonry Block - Stru	0.800	0.20	0.18	2.57	FOUNDATION
Basic Wall:wall exteri	7777	Masonry Block - Stru	0.800	0.20	0.02	1.36	FOUNDATION
Basic Wall:wall exteri	7777	Masonry Block - Stru	0.950	0.20	1.83	19.82	FOUNDATION
Basic Wall:wall exteri	777	Masonry Block - Stru	0.800	0.20	1.25	13.33	FOUNDATION
Basic Wall:wall exteri	7774	Masonry Block - Stru	0.800	0.20	0.72	8.00	FOUNDATION
Basic Wall:wall exteri	777	Masonry Block - Stru	0.800	0.20	1.53	18.32	FOUNDATION
Basic Wall:wall exteri	777	Masonry Block - Stru	0.800	0.20	0.87	10.07	FOUNDATION
Basic Wall:wall exteri	7777	Masonry Block - Stru	1.050	0.20	0.87	9.90	FOUNDATION
Basic Wall:wall exteri	777	Masonry Block - Stru	0.800	0.20	0.99	10.97	FOUNDATION
Basic Wall:wall exteri		ex. wall brick	0.700	0.20	0.54	5.68	Terrace/Roof
Basic Wall:wallrec:21		ex. wall brick	0.600	0.15	8.54	114.93	Level 1
Basic Wall:wallrec:21 Basic Wall:wallrec:21			0.600	0.15 0.20	8.54 2.24	114.93 23.12	Level 1
		ex. wall brick					
Basic Wall:wallrec:21		ex. wall brick ex. wall brick	0.600	0.20	2.24	23.12	Level 1
Basic Wall:wallrec:21 Basic Wall:wallrec:21		ex. wall brick ex. wall brick ex. wall brick	0.600	0.20	2.24	23.12	Level 1
Basic Wall:wallrec:21 Basic Wall:wallrec:21 Basic Wall:wallrec:21		ex. wall brick	0.600 0.600 0.600	0.20 0.15 0.15 0.20	2.24 3.13 6.16 0.32 1.18	23.12 42.09 83.16 3.47 12.48	Level 1 Level 1 Level 1
Basic Wall:wallrec:21 Basic Wall:wallrec:21 Basic Wall:wallrec:21 Basic Wall:wallrec:21 Basic Wall:wallrec:21 Basic Wall:wallrec:21		ex. wall brick	0.600 0.600 0.600 0.600 0.600	0.20 0.15 0.15 0.20 0.20 0.20	2.24 3.13 6.16 0.32 1.18 5.65	23.12 42.09 83.16 3.47 12.48 59.84	Level 1
Basic Waltwallrect21		ex. wall brick	0.600 0.600 0.600 0.600 0.600 0.600	0.20 0.15 0.15 0.20 0.20 0.20 0.10	2.24 3.13 6.16 0.32 1.18 5.65 0.28	23.12 42.09 83.16 3.47 12.48 59.84 5.69	Level 1
Basic Waltwalrec:21		ex. wall brick	0.600 0.600 0.600 0.600 0.600 0.600 0.600	0.20 0.15 0.15 0.20 0.20 0.20 0.10 0.20	2.24 3.13 6.16 0.32 1.18 5.65 0.28 2.50	23.12 42.09 83.16 3.47 12.48 59.84 5.69 25.89	Level 1
Basic Waltwalrec:21		ex. wall brick	0.600 0.600 0.600 0.600 0.600 0.600 0.600 0.600	0.20 0.15 0.15 0.20 0.20 0.20 0.10 0.20	2.24 3.13 6.16 0.32 1.18 5.65 0.28 2.50 0.68	23.12 42.09 83.16 3.47 12.48 59.84 5.69 25.89	Level 1
Basic Waltwalfrec;21		ex. wall brick	0.600 0.600 0.600 0.600 0.600 0.600 0.600 0.600 0.600	0.20 0.15 0.15 0.20 0.20 0.20 0.20 0.10 0.20 0.10 0.20	2.24 3.13 6.16 0.32 1.18 5.65 0.28 2.50 0.68 3.23	23.12 42.09 83.16 3.47 12.48 59.84 5.69 25.89 14.37 33.37	Level 1
Basic Waltwalfrec;21		ex. wall brick	0.600 0.600 0.600 0.600 0.600 0.600 0.600 0.600 0.600	0.20 0.15 0.15 0.20 0.20 0.20 0.10 0.20 0.10 0.20	2.24 3.13 6.16 0.32 1.18 5.65 0.28 2.50 0.68 3.23 0.96	23.12 42.09 83.16 3.47 12.48 59.84 59.84 14.37 33.37 19.77	Level 1
Basic Waltwalfrec;21		ex. wall brick	0.600 0.600 0.600 0.600 0.600 0.600 0.600 0.600 0.600 0.600	0.20 0.15 0.15 0.20 0.20 0.20 0.20 0.10 0.20 0.10 0.20 0.10 0.20	2.24 3.13 6.16 0.32 1.18 5.65 0.28 2.50 0.68 3.23 0.96 0.99	23.12 42.09 83.16 3.47 12.48 59.84 5.89 14.37 33.37 19.77	Level 1
Basic Waltwalrec;21		ex. wall brick	0.600 0.600 0.600 0.600 0.600 0.600 0.600 0.600 0.600 0.600 0.600	0.20 0.15 0.15 0.20 0.20 0.20 0.20 0.10 0.20 0.10 0.20 0.10 0.20 0.110 0.20 0.110	2.24 3.13 6.16 0.32 1.18 5.65 0.28 2.50 0.68 3.23 0.96 0.99 0.49	23.12 42.09 83.16 3.47 12.48 59.84 5.69 25.89 14.37 33.37 19.77 10.06	Level 1
Basic Waltwalfree:21		ex. wall brick	0.600 0.600 0.600 0.600 0.600 0.600 0.600 0.600 0.600 0.600 0.600 0.600	0.20 0.15 0.20 0.20 0.20 0.20 0.10 0.20 0.10 0.20 0.10 0.20 0.11 0.20 0.15	2.24 3.13 6.16 0.32 1.18 5.65 0.28 2.50 0.68 3.23 0.96 0.99 0.49 0.72	23.12 42.09 83.16 3.47 12.48 59.84 5.69 25.89 14.37 33.37 19.77 10.06 7.14	Level 1
Basic Waltwalfrec;21		ex. wall brick	0.600 0.600 0.600 0.600 0.600 0.600 0.600 0.600 0.600 0.600 0.600 0.600 0.600 0.600 0.600	0.20 0.15 0.20 0.20 0.20 0.20 0.10 0.20 0.10 0.20 0.11 0.20 0.15 0.20 0.10	2.24 3.13 6.16 0.32 1.18 5.65 0.28 2.50 0.68 3.23 0.96 0.99 0.49 0.72 1.15	23.12 42.09 83.16 3.47 12.48 5.69 25.89 14.37 33.37 19.77 10.06 7.14 7.91	Level 1
Basic Waltwalfrec;21		ex. wall brick	0.600 0.600 0.600 0.600 0.600 0.600 0.600 0.600 0.600 0.600 0.600 0.600 0.600 0.600 0.600 0.600	0.20 0.15 0.15 0.20 0.20 0.20 0.10 0.20 0.10 0.20 0.110 0.20 0.15 0.20 0.10 0.20 0.10 0.20	2.24 3.13 6.16 0.32 1.18 5.65 0.28 2.50 0.68 3.23 0.96 0.99 0.49 0.72 1.15 1.96	23.12 42.09 83.16 3.47 12.48 59.84 5.69 25.89 14.37 33.37 19.77 10.06 7.14 7.91 23.82 20.28	Level 1
Basic Waltwalrec;21		ex. wall brick	0.600 0.600 0.600 0.600 0.600 0.600 0.600 0.600 0.600 0.600 0.600 0.600 0.600 0.600 0.600 0.600 0.600 0.600	0.20 0.15 0.15 0.20 0.20 0.20 0.20 0.20 0.10 0.20 0.10 0.20 0.11 0.20 0.11 0.20 0.15	2.24 3.13 6.16 0.32 1.18 5.65 0.28 2.50 0.68 3.23 0.96 0.99 0.72 1.15 1.96	23.12 42.09 83.16 3.47 12.48 59.84 5.89 25.89 14.37 33.37 19.77 10.06 7.14 7.91 23.82 20.28	Level 1
Basic Waltwalrec;21		ex. wall brick	0.600 0.600 0.600 0.600 0.600 0.600 0.600 0.600 0.600 0.600 0.600 0.600 0.600 0.600 0.600 0.600 0.600 0.600	0.20 0.15 0.15 0.20 0.20 0.20 0.10 0.20 0.10 0.20 0.11 0.20 0.15 0.20 0.10 0.20 0.10 0.20 0.10 0.20 0.10 0.20 0.20 0.20 0.20 0.20 0.20 0.10 0.20 0.10 0.20 0.10 0.20 0.20 0.20 0.10 0.20	2.24 3.13 6.16 0.32 1.18 5.65 0.28 2.50 0.68 3.23 0.96 0.99 0.72 1.15 1.96 1.13 0.00	23.12 42.09 83.16 3.47 12.48 59.84 5.89 25.89 14.37 33.37 19.77 10.06 7.14 7.91 23.82 20.28	Level 1
Basic Waltwalrec;21		ex. wall brick	0.600 0.600 0.600 0.600 0.600 0.600 0.600 0.600 0.600 0.600 0.600 0.600 0.600 0.600 0.600 0.600 0.600 0.600	0.20 0.15 0.15 0.15 0.20 0.20 0.20 0.10 0.20 0.10 0.20 0.11 0.20 0.11 0.20 0.15 0.20 0.15 0.20 0.10 0.20 0.10 0.20 0.10 0.20 0.20	2.24 3.13 6.16 0.32 1.18 5.65 0.28 2.50 0.68 3.23 0.96 0.99 0.72 1.15 1.96 1.13 0.00 0.55	23.12 42.09 83.16 3.47 12.48 59.84 5.89 25.89 14.37 33.37 10.06 7.14 7.91 23.82 20.28 12.00 6.47 6.30	Level 1 Level
Basic Waltwalrec;21		ex. wall brick	0.600 0.6000 0.6000 0.6000 0.6000 0.600 0.	0.20 0.15 0.15 0.15 0.20 0.20 0.20 0.20 0.10 0.20 0.10 0.20 0.11 0.20 0.11 0.20 0.15 0.20 0.15 0.20 0.10 0.20 0.10 0.20 0.10 0.20 0.20	2.24 3.13 6.16 0.32 1.18 5.65 0.28 2.50 0.68 3.23 0.96 0.99 0.49 0.72 1.15 1.96 1.13 0.00 0.55 0.57	23.12 42.09 83.16 3.47 12.48 59.84 5.69 25.89 14.37 33.37 19.77 10.06 7.14 7.91 23.82 20.28 6.47 6.30 5.90	Level 1 Level
Basic Waltwalrec;21		ex. wall brick ex. wa	0.600 0.600	0.20 0.15 0.15 0.20 0.15 0.20 0.20 0.20 0.10 0.20 0.10 0.20 0.11 0.20 0.11 0.20 0.15 0.20 0.15 0.20 0.10 0.20 0.20 0.20 0.20 0.20 0.20	2.24 3.13 6.16 0.32 1.18 5.65 0.28 2.50 0.68 3.23 0.96 0.99 0.72 1.15 1.96 1.13 0.00 0.55 0.57	23.12 42.09 83.16 3.47 12.48 5.69 25.89 14.37 33.37 19.77 10.06 7.14 7.91 23.82 20.28 12.00 6.47 6.30 5.90	Level 1 Level
Basic Waltwalrec;21		ex. wall brick ex. wa	0.600 0.600 0.600 0.600 0.600 0.600 0.600 0.600 0.600 0.600 0.600 0.600 0.600 0.600 0.600 0.600 0.700 0.700 0.700	0.20 0.15 0.15 0.20 0.15 0.20 0.20 0.20 0.20 0.10 0.20 0.10 0.20 0.10 0.20 0.10 0.20 0.10 0.20 0.10 0.20 0.2	2.24 3.13 6.16 0.32 1.18 5.65 0.28 2.50 0.68 3.23 0.96 0.99 0.72 1.15 1.19 0.00 0.55 0.55	23.12 42.09 83.16 3.47 12.48 5.69 25.89 14.37 33.37 19.77 10.06 7.14 7.91 23.82 20.28 12.00 6.47 5.90 6.47	Level 1 Cevel 1 Level 1 Level 1 Cevel 1 Level 1 Level 1 Cevel 1 Level 1 Cevel
Basic Waltwalrec;21		ex. wall brick ex. wa	0.600 0.700 0.700	0.20 0.15 0.15 0.20 0.15 0.20 0.20 0.20 0.20 0.10 0.20 0.10 0.20 0.10 0.20 0.10 0.20 0.10 0.20 0.10 0.20 0.10 0.20 0.2	2.24 3.13 6.16 0.32 1.18 5.65 0.28 2.50 0.68 3.23 0.96 0.99 0.72 1.15 1.90 1.13 0.00 0.55 0.55 0.55	23.12 42.09 83.16 3.47 12.48 59.84 5.69 25.89 14.37 33.37 19.77 10.06 7.14 7.91 23.82 20.28 12.00 6.47 6.30 5.90 5.90 6.47 8.47	Level 1 Cevel 1 Level
Basic Waltwalrec;21		ex. wall brick ex. wa	0.600 0.600 0.600 0.600 0.600 0.600 0.600 0.600 0.600 0.600 0.600 0.600 0.600 0.600 0.600 0.600 0.600 0.700 0.700 0.700 0.700 0.700 0.700 0.700 0.700 0.700 0.700 0.700	0.20 0.15 0.15 0.15 0.20 0.20 0.20 0.20 0.10 0.20 0.10 0.20 0.11 0.20 0.11 0.20 0.15 0.20 0.20 0.20 0.20 0.20 0.20 0.20 0.2	2.24 3.13 6.16 0.32 1.18 5.65 0.28 2.50 0.68 2.50 0.99 0.49 0.72 1.15 1.96 1.13 0.05 0.55 0.55 0.55	23.12 42.09 83.16 3.47 12.48 59.84 5.89 25.89 14.37 33.37 19.77 10.06 7.14 7.91 23.82 20.28 12.00 6.47 6.30 5.90 6.47 8.47 6.47	Level 1 Level
Basic Waltwalrec;21		ex. wall brick ex. wa	0.600 0.700 0.700	0.20 0.15 0.15 0.15 0.20 0.20 0.20 0.20 0.10 0.20 0.10 0.20 0.11 0.20 0.15 0.20 0.10 0.20 0.10 0.20 0.10 0.20 0.20	2.24 3.13 6.16 0.32 1.18 5.65 0.28 2.50 0.88 2.50 0.99 0.49 0.72 1.15 1.96 1.13 0.00 0.55 0.55 0.55 0.55	23.12 42.09 83.16 3.47 12.48 59.84 5.69 25.89 14.37 33.37 10.06 7.14 7.91 23.82 20.28 12.00 6.47 6.30 5.90 5.90 6.47 6.47 6.47	Level 1 FOUNDATION
Basic Waltwalrec;21		ex. wall brick Masonry Block - Stru ex. wall brick	0.600 0.600 0.600 0.600 0.600 0.600 0.600 0.600 0.600 0.600 0.600 0.600 0.600 0.600 0.600 0.600 0.600 0.700 0.700 0.700 0.700 0.700 0.700 0.700 0.700 0.700 0.700 0.700	0.20 0.15 0.15 0.15 0.20 0.20 0.20 0.20 0.10 0.20 0.10 0.20 0.11 0.20 0.11 0.20 0.15 0.20 0.20 0.20 0.20 0.20 0.20 0.20 0.2	2.24 3.13 6.16 0.32 1.18 5.65 0.28 2.50 0.68 2.50 0.99 0.49 0.72 1.15 1.96 1.13 0.05 0.55 0.55 0.55	23.12 42.09 83.16 3.47 12.48 5.69 25.89 14.37 33.37 19.77 10.06 7.14 7.91 23.82 20.28 12.00 6.47 6.30 5.90 6.47 6.47 6.47 6.47	Level 1 Level
Basic Waltwalrec;21		ex. wall brick ex. wa	0.600 0.6000 0.6000 0.6	0.20 0.15 0.15 0.15 0.20 0.20 0.20 0.20 0.10 0.20 0.10 0.20 0.11 0.20 0.11 0.20 0.15 0.20 0.20 0.20 0.20 0.20 0.20 0.20 0.2	2.24 3.13 6.16 0.32 1.18 5.65 0.28 3.23 0.96 0.99 0.79 1.15 1.96 1.13 0.00 0.55 0.55 0.75 0.55 0.75 1.26	23.12 42.09 83.16 3.47 12.48 59.84 5.69 25.89 14.37 33.37 10.06 7.14 7.91 23.82 20.28 12.00 6.47 6.30 5.90 5.90 6.47 6.47 6.47	Level 1 FOUNDATION
Basic Waltwalrec;21		ex. wall brick dasonry Block - Stru Masonry Block - Stru ex. wall brick ex. wall brick	0.600 0.600 0.600 0.600 0.600 0.600 0.600 0.600 0.600 0.600 0.600 0.600 0.600 0.600 0.200 0.700	0.20 0.15 0.15 0.20 0.15 0.20 0.20 0.20 0.20 0.10 0.20 0.10 0.20 0.11 0.20 0.15 0.20 0.10 0.20 0.20 0.20 0.20 0.20 0.20	2.24 3.13 6.16 0.32 1.18 2.50 0.68 3.23 0.96 0.72 1.15 1.99 0.72 1.15 0.00 0.55 0.57 0.55 0.75 0.75	23.12 42.09 83.16 3.47 12.48 5.69 25.89 14.37 33.37 19.77 10.06 7.14 7.91 23.82 20.28 12.00 6.47 6.30 5.90 6.47 6.47 6.47 6.47 6.47 6.47 6.47 6.47	Level 1
Basic Waltwalrec;21		ex. wall brick Masonry Block - Stru ex. wall brick ex. wall brick ex. wall brick linterior Wall	0.600 0.600 0.600 0.600 0.600 0.600 0.600 0.600 0.600 0.600 0.600 0.600 0.600 0.600 0.700	0.20 0.15 0.15 0.15 0.20 0.20 0.20 0.10 0.20 0.10 0.20 0.10 0.20 0.11 0.20 0.11 0.20 0.12 0.20 0.20	2.24 3.13 6.16 0.32 1.18 5.65 0.28 2.50 0.68 3.23 0.96 0.49 0.72 1.15 1.99 0.55 0.55 0.55 0.55 0.75	23.12 42.09 83.16 3.47 12.48 5.69 25.89 14.37 33.37 19.77 10.06 7.14 7.91 23.82 20.28 12.00 6.47 6.30 5.90 6.47 8.47 6.47	Level 1
Basic Waltwalrec;21		ex. wall brick	0.600 0.600 0.600 0.600 0.600 0.600 0.600 0.600 0.600 0.600 0.600 0.600 0.600 0.700	0.20 0.15 0.15 0.15 0.20 0.20 0.20 0.20 0.10 0.20 0.10 0.20 0.11 0.20 0.11 0.20 0.15 0.20 0.20 0.20 0.20 0.20 0.20 0.20 0.2	2.24 3.13 6.16 0.32 1.18 2.50 0.68 3.23 3.23 0.96 0.99 0.49 0.72 1.15 1.96 0.55 0.57 0.55 0.75 0.55 0.75 0.55	23.12 42.09 83.16 3.47 12.48 59.84 5.69 25.89 14.37 33.37 19.77 10.06 7.14 7.91 23.82 20.28 12.00 6.47 6.30 5.90 6.47 6.47 8.47 8.47 13.20 13.53 8.30	Level 1
Basic Waltwalrec;21		ex. wall brick	0.600 0.600 0.600 0.600 0.600 0.600 0.600 0.600 0.600 0.600 0.600 0.600 0.600 0.700	0.20 0.15 0.15 0.15 0.20 0.20 0.20 0.20 0.10 0.20 0.10 0.20 0.11 0.20 0.15 0.20 0.10 0.20 0.15 0.20 0.20 0.20 0.20 0.20 0.20 0.20 0.2	2.24 3.13 6.16 0.32 1.18 2.50 0.68 3.23 0.98 0.72 1.15 1.90 0.55 0.57 0.55 0.75 0.75 0.75 0.75 0.12 0.50 0.12	23.12 42.09 83.16 3.47 12.48 59.84 5.69 25.89 14.37 33.37 19.77 10.06 7.14 7.91 23.82 20.28 12.00 6.47 6.30 5.90 6.47 6.47 6.47 6.47 8.47 13.20 1.78 5.70 13.53 8.30 16.32	Level 1
Basic Waltwalrec;21		ex. wall brick interior Block - Stru Masonry Block - Stru Masonry Block - Stru Masonry Block - Stru ex. wall brick	0.600 0.600 0.600 0.600 0.600 0.600 0.600 0.600 0.600 0.600 0.600 0.600 0.600 0.700 0.700 0.700 0.700 0.700 0.700 0.600	0.20 0.15 0.15 0.15 0.20 0.20 0.20 0.20 0.10 0.20 0.10 0.20 0.11 0.20 0.11 0.20 0.15 0.20 0.20 0.20 0.20 0.20 0.20 0.20 0.2	2.24 3.13 6.16 0.32 1.18 2.50 0.88 3.23 0.96 0.72 1.15 1.96 0.55 0.57 0.55 0.75 1.26 0.12 0.50 1.31 0.58	23.12 42.09 83.16 3.47 12.48 5.69 25.89 14.37 33.37 19.77 10.06 7.14 7.91 23.82 20.28 12.00 6.47 6.30 5.90 6.47 8.47 13.20 1.78 6.47 8.47 13.20 1.78 5.70 13.53 8.30	Level 1
Basic Waltwalrec; 21		ex. wall brick interior brit. Masonry Block - Stru ex. wall brick ex. wall brick ex. wall brick interior Wall ex. wall brick	0.600 0.600 0.600 0.600 0.600 0.600 0.600 0.600 0.600 0.600 0.600 0.600 0.700	0.20 0.15 0.15 0.15 0.20 0.20 0.20 0.20 0.20 0.10 0.20 0.10 0.20 0.11 0.20 0.11 0.20 0.15 0.20 0.20 0.20 0.20 0.20 0.20 0.20 0.2	2.24 3.13 6.16 0.32 1.18 2.50 0.88 3.23 0.96 0.72 1.15 1.96 0.55 0.55 0.75 0.55 0.75 1.26 0.12 0.50 0.12 0.50 0.50 0.50 0.50 0.50 0.50 0.50 0.5	23.12 42.09 83.16 3.47 12.48 98.44 5.69 25.89 14.37 33.37 19.77 10.06 7.14 7.91 23.82 20.28 12.00 6.47 6.30 5.90 5.90 6.47 8.47 6.47 6.47 13.20 1.78 5.70 13.53 8.30 16.32	Level 1 Level
Basic Waltwalrec;21		ex. wall brick interior Block - Stru Masonry Block - Stru Masonry Block - Stru Masonry Block - Stru ex. wall brick	0.600 0.600 0.600 0.600 0.600 0.600 0.600 0.600 0.600 0.600 0.600 0.600 0.600 0.700 0.700 0.700 0.700 0.700 0.700 0.600	0.20 0.15 0.15 0.15 0.20 0.20 0.20 0.20 0.10 0.20 0.10 0.20 0.11 0.20 0.11 0.20 0.15 0.20 0.20 0.20 0.20 0.20 0.20 0.20 0.2	2.24 3.13 6.16 0.32 1.18 2.50 0.88 3.23 0.96 0.72 1.15 1.96 0.55 0.57 0.55 0.75 1.26 0.12 0.50 1.31 0.58	23.12 42.09 83.16 3.47 12.48 5.69 25.89 14.37 33.37 19.77 10.06 7.14 7.91 23.82 20.28 12.00 6.47 6.30 5.90 6.47 8.47 13.20 1.78 6.47 8.47 13.20 1.78 5.70 13.53 8.30	Level 1
Basic Waltwalrec;21		ex. wall brick	0.600 0.600	0.20 0.15 0.15 0.20 0.15 0.20 0.20 0.20 0.20 0.10 0.20 0.10 0.20 0.10 0.20 0.10 0.20 0.10 0.20 0.10 0.20 0.11 0.20 0.15 0.20 0.20 0.20 0.20 0.20 0.20 0.20 0.2	2.24 3.13 6.16 0.32 1.18 5.65 0.28 2.50 0.68 3.23 0.96 0.49 0.72 1.15 1.99 0.55 0.55 0.75 0.55 0.75 0.55 0.75 0.55 0.12 0.50 0.12 0.50 0.12 0.50 0.12 0.50 0.12 0.50 0.12 0.50 0.12 0.50 0.13 0.13 0.13 0.13 0.13 0.13 0.13 0.1	23.12 42.09 83.16 3.47 12.48 59.84 5.89 25.89 14.37 33.37 19.77 10.06 7.14 7.91 23.82 20.28 12.00 6.47 6.30 5.90 6.47 8.47 13.20 1.78 8.47 13.20 1.78 1.7	Level 1 Level
Basic Waltwalrec;21		ex. wall brick interior Block - Stru Masonry Block - Stru Masonry Block - Stru Masonry Block - Stru ex. wall brick	0.600 0.600	0.20 0.15 0.15 0.15 0.20 0.20 0.20 0.20 0.10 0.20 0.10 0.20 0.11 0.20 0.11 0.20 0.15 0.20 0.10 0.20 0.15 0.20 0.20 0.20 0.20 0.20 0.20 0.20 0.2	2.24 3.13 6.16 0.32 1.18 2.50 0.68 3.23 0.99 0.49 0.72 1.15 1.96 0.55 0.57 0.55 0.75 0.55 0.75 0.12 0.50 0.12 0.10 0.10 0.10 0.10 0.10 0.10 0.1	23.12 42.09 83.16 3.47 12.48 59.84 5.69 25.89 14.37 33.37 19.77 10.06 7.14 7.91 23.82 20.28 12.00 6.47 6.30 5.90 6.47 8.47 6.47 6.47 13.20 1.78 5.70 13.53 8.30 15.51 11.02	Level 1 Level
Basic Waltwalrec;21		ex. wall brick	0.600 0.700 0.700 0.700	0.20 0.15 0.15 0.15 0.20 0.16 0.20 0.20 0.10 0.20 0.10 0.20 0.11 0.20 0.11 0.20 0.11 0.20 0.12 0.20 0.20	2.24 3.13 6.16 0.32 1.18 2.50 0.68 3.23 0.99 0.49 0.72 1.15 1.96 0.55 0.57 0.55 0.75 0.55 0.75 0.55 0.128 0.00 0.00 0.00 0.00 0.00 0.00 0.00 0.	23.12 42.09 83.16 3.47 12.48 59.84 5.69 25.89 14.37 33.37 19.77 10.06 7.14 7.91 23.82 20.28 12.00 6.47 6.30 5.90 6.47 6.31 13.20 1.78 8.47 13.20 1.78 8.47 13.20 1.78 8.30 16.32 8.30 16.32 8.30 16.32 8.30 5.51 11.02 20.46	Level 1 Level
Basic Waltwalrec;21		ex. wall brick interior brick ex. wall brick	0.600 0.600	0.20 0.15 0.15 0.15 0.20 0.20 0.20 0.20 0.10 0.20 0.10 0.20 0.11 0.20 0.11 0.20 0.15 0.20 0.15 0.20 0.20 0.20 0.20 0.20 0.20 0.20 0.2	2.24 3.13 6.16 0.32 1.18 2.50 0.88 3.23 0.96 0.72 1.15 1.96 0.00 0.55 0.57 0.55 0.75 0.75 0.75 1.26 0.12 0.50 0.12 0.50 0.12 0.50 0.12 0.50 0.12 0.50 0.12 0.50 0.12 0.50 0.12 0.50 0.12 0.50 0.50 0.50 0.50 0.50 0.50 0.50 0.5	23.12 42.09 83.16 3.47 12.48 59.84 5.69 25.89 14.37 33.37 19.77 10.06 7.14 7.91 23.82 20.28 12.00 6.47 6.30 5.90 6.47 6.47 8.47 13.20 1.78 5.70 13.53 8.30 16.32 8.30 5.51 11.02 20.46 10.06 7.92	Level 1 Level

	Wall Schedule											
•	Element ID	Element ID 2D Plan Preview		Height [m]	Thickness [m]	Area [m2]	Perimeter [m]	Home Story Name				
	CSEB 290 BRICKS		ex. wall brick	3.400	0.15	0.29	8.10	Ground Floor				
٦	CSEB 290 BRICKS		ex. wall brick	3.527	0.20	1.02	13.89	Ground Floor				
٦	CSEB 290 BRICKS	_	ex. wall brick	3.600	0.05	0.10	7.08	Ground Floor				
٦	CSEB 290 BRICKS		ex. wall brick	3.600	0.15	1.31	21.65	Ground Floor				
٦	CSEB 290 BRICKS		ex. wall brick	3.600	0.20	15.89	187.98	Ground Floor				
1	CSEB 290 BRICKS		ex. wall brick	3.650	0.20	1.07	13.25	Ground Floor				
7	CSEB 290 BRICKS		ex. wall brick	4.300	0.20	1.67	23.30	Ground Floor				
7	CSEB 290 BRICKS		GENERIC - STRUC	3.600	0.20	1.16	57.95	Ground Floor				
7	SW - 002		GENERIC - STRUC	0.600	0.20	0.96	10.80	Level 1				
1	SW - 003		GENERIC - STRUC	0.300	0.20	0.22	2.48	Terrace/Roof				
	SW - 004		GENERIC - STRUC	0.300	0.20	1.04	10.97	Terrace/Roof				
7	SW - 005		GENERIC - STRUC	0.300	0.20	0.18	2.48	Terrace/Roof				



GREATER BANJUL THE GAMBIA

+220 3766269/2351601 Designed By: Structures Design Drawn by: A.H.Jow, A. O. Tamba & A. Marigo Checked by: A.H.Jow, A. O. Tamba & A. Marigo

THE INFORMATION CONTAINED HEREIN IS BELIEVED TO BE CORRECT.HOWEVER, REPORT ANY OMISSION OR ERROR TO Structures Design

RevID	ChID	Change Name	Date

WESTCOAST REGION

THE GAMBIA SALAJI

CLIENT: EARTH BUILDER'S ASSOCIATION

REGION: COUNTRY: SITE:

WARNING NOTE

THIS DRAWING IS NOT TO BE REPRODUCED BY ANY MEANS, OR HANDED OVER TO A THIRD PARTY WITHOUT PRIOR CONSULTAION WITH AND CONSENT OF STRUCTURES DESIGN

PROJECT SITE AREA: 1000m² Proposed Building Area: 285.448m²

DATE 5/22/2022

SCALE 1:2

S.01.3

Wall schedule

		Beam/Trenches Schedul	e				Beam/Trenches Schedul	e				Beam/Trenches Schedul			
2D Plan Preview	Home Story Name	Building Material	Thickness	Quantity	2D Plan Preview	Home Story Name	Building Material	Thickness	Quantity	2D Plan Preview	Home Story Name	Building Material	Thickness	Quantity	20
8000	FOUNDATION	Reinforced Concrete - Structural	0.150	1	<u></u>	FOUNDATION	Soakaway/Septic Tank Trenches	0.001	1	8008	Ground Floor	Reinforced Concrete - Beam	0.200	1	L
	FOUNDATION	Reinforced Concrete - Structural	0.150	1	<u></u>	FOUNDATION	Main Building Trenches	0.001	1	8038	Ground Floor	Reinforced Concrete - Beam	0.200	1	L
<u></u>	FOUNDATION	Reinforced Concrete Footing	0.200	1	==	FOUNDATION	Main Building Trenches	0.001	1	8008	Ground Floor	Reinforced Concrete - Beam	0.200	1	
	FOUNDATION	Reinforced Concrete Footing	0.200	1	<u></u>	FOUNDATION	Main Building Trenches	0.001	1	8008	Ground Floor	Reinforced Concrete - Beam	0.200	1	
	FOUNDATION	Reinforced Concrete Footing	0.200	1	<u>==</u>	FOUNDATION	Main Building Trenches	0.001	1	8008	Ground Floor	Reinforced Concrete - Beam	0.200	1	
	FOUNDATION	Reinforced Concrete Footing	0.200	1	E-3	FOUNDATION	Main Building Trenches	0.001	1	8008	Ground Floor	Reinforced Concrete - Beam	0.200	1	
	FOUNDATION	Reinforced Concrete Footing	0.200	1	<u></u>	FOUNDATION	Main Building Trenches	0.001	1	8538	Ground Floor	Reinforced Concrete - Beam	0.200	1	1
<u></u>	FOUNDATION	Reinforced Concrete Footing	0.200	1	<u></u>	FOUNDATION	Main Building Trenches	0.001	1	8538	Ground Floor	Reinforced Concrete - Beam	0.200	1	1
<u></u>	FOUNDATION	Reinforced Concrete Footing	0.200	1	E	FOUNDATION	Main Building Trenches	0.001	1	8008	Ground Floor	Reinforced Concrete - Beam	0.200	1	
<u></u>	FOUNDATION	Reinforced Concrete Footing	0.200	1	<u>==</u>	FOUNDATION	Main Building Trenches	0.001	1	8008	Ground Floor	Reinforced Concrete - Beam	0.200	1	
<u></u>	FOUNDATION	Reinforced Concrete Footing	0.200	1	<u>==</u>	FOUNDATION	Main Building Trenches	0.001	1	8008	Ground Floor	Reinforced Concrete - Beam	0.200	1	
<u></u>	FOUNDATION	Reinforced Concrete Footing	0.200	1	<u></u>	FOUNDATION	Main Building Trenches	0.001	1	8008	Ground Floor	Reinforced Concrete - Beam	0.200	1	
<u></u>	FOUNDATION	Reinforced Concrete Footing	0.200	1	□	FOUNDATION	Main Building Trenches	0.001	1	8008	Ground Floor	Reinforced Concrete - Beam	0.200	1	
	FOUNDATION	Reinforced Concrete Footing	0.200	1	<u></u>	FOUNDATION	Main Building Trenches	0.001	1	8008	Ground Floor	Reinforced Concrete - Beam	0.200	1	1
	FOUNDATION	Reinforced Concrete Footing	0.200	1	<u></u>	FOUNDATION	Main Building Trenches	0.001	1	8008	Ground Floor	Reinforced Concrete - Beam	0.200	1	1
	FOUNDATION	Reinforced Concrete Footing	0.200	1	<u></u>	FOUNDATION	Main Building Trenches	0.001	1	8008	Ground Floor	Reinforced Concrete - Beam	0.200	1	
	FOUNDATION	Reinforced Concrete Footing	0.200	1	<u></u>	FOUNDATION	Main Building Trenches	0.001	1	8008	Ground Floor	Reinforced Concrete - Beam	0.200	1	
	FOUNDATION	Reinforced Concrete Footing	0.200	1	<u>=</u>	FOUNDATION	Main Building Trenches	0.001	1	8008	Ground Floor	Reinforced Concrete - Beam	0.200	1	
FF	FOUNDATION	Reinforced Concrete Footing	0.200	1	<u>=</u>	FOUNDATION	Main Building Trenches	0.001	1	8008	Ground Floor	Reinforced Concrete - Beam	0.200	1	1
FF	FOUNDATION	Reinforced Concrete Footing	0.200	1	<u>==</u>	FOUNDATION	Main Building Trenches	0.001	1	9000	Ground Floor	Reinforced Concrete - Beam	0.200	1	1
FF	FOUNDATION	Reinforced Concrete Footing	0.200	1	<u></u>	FOUNDATION	Main Building Trenches	0.001	1	9000	Ground Floor	Reinforced Concrete - Beam	0.200	1	1
F	FOUNDATION	Reinforced Concrete Footing	0.200	1	<u></u>	FOUNDATION	Main Building Trenches	0.001	1	8538	Ground Floor	Reinforced Concrete - Beam	0.200	1	1
	FOUNDATION	Reinforced Concrete Footing	0.200	1	<u></u>	FOUNDATION	Main Building Trenches	0.001	1	8008	Ground Floor	Reinforced Concrete - Beam	0.200	1	
	FOUNDATION	Reinforced Concrete Footing	0.200	1		FOUNDATION	Main Building Trenches	0.001	1	8538	Ground Floor	Reinforced Concrete - Beam	0.200	1	1
<u> </u>	FOUNDATION	Reinforced Concrete Footing	0.200	1	<u></u>	FOUNDATION	Main Building Trenches	0.001	1	8008	Ground Floor	Reinforced Concrete - Beam	0.200	1	1
	FOUNDATION	Reinforced Concrete Footing	0.200	1	<u></u>	FOUNDATION	Main Building Trenches	0.001	1	8538	Ground Floor	Reinforced Concrete - Beam	0.200	1	1
	FOUNDATION	Reinforced Concrete Footing	0.200	1	<u></u>	FOUNDATION	Main Building Trenches	0.001	1	8008	Ground Floor	Reinforced Concrete - Beam	0.200	1	1
	FOUNDATION	Reinforced Concrete Footing	0.200	1	<u>==</u>	FOUNDATION	Main Building Trenches	0.001	1	8008	Ground Floor	Reinforced Concrete - Beam	0.200	1	1
<u> </u>	FOUNDATION	Reinforced Concrete Footing	0.200	1	<u> </u>	FOUNDATION	Main Building Trenches	0.001	1	===	Ground Floor	Reinforced Concrete - Ground Beam	0.300	1	1
	FOUNDATION	Reinforced Concrete Footing	0.200	1	<u></u>	FOUNDATION	Main Building Trenches	0.001	1	===	Ground Floor	Reinforced Concrete - Ground Beam	0.300	1	1
	FOUNDATION	Reinforced Concrete Footing	0.200	1	<u> </u>	FOUNDATION	Main Building Trenches	0.001	1	===	Ground Floor	Reinforced Concrete - Ground Beam	0.300	1	1
	FOUNDATION		0.200	1	<u> </u>	FOUNDATION	Main Building Trenches	0.001	1	===	Ground Floor	Reinforced Concrete - Ground Beam	0.300	1	1
	FOUNDATION	Reinforced Concrete Soakaway/Septic Tank	0.150	1	<u> </u>	FOUNDATION	Main Building Trenches	0.001	1	===	Ground Floor	Reinforced Concrete - Ground Beam	0.300	1	1
	FOUNDATION	Reinforced Concrete Soakaway/Septic Tank	0.150	1	8508	Ground Floor	Reinforced Concrete - Beam	0.200	1	===	Ground Floor	Reinforced Concrete - Ground Beam	0.300	1	1
<u></u>	FOUNDATION	Reinforced Concrete Soakaway/Septic Tank	0.150	1	8538	Ground Floor	Reinforced Concrete - Beam	0.200	1	===	Ground Floor	Reinforced Concrete - Ground Beam	0.300	1	1
	FOUNDATION	Reinforced Concrete Soakaway/Septic Tank	0.200	1	8008	Ground Floor	Reinforced Concrete - Beam	0.200	1	E33	Ground Floor	Reinforced Concrete - Ground Beam	0.300	1	1
	FOUNDATION	Footing Soakaway/Septic Tank Trenches		1	8008	Ground Floor	Reinforced Concrete - Beam	0.200	1	E-3	Ground Floor	Reinforced Concrete - Ground Beam	0.300	1	1
	FOUNDATION	Soakaway/Septic Tank Trenches		1	8559	Ground Floor	Reinforced Concrete - Beam	0.200	1		Ground Floor	Reinforced Concrete - Ground Beam	0.300	1	1
	FOUNDATION	Soakaway/Septic Tank Trenches	0.001	1	8508	Ground Floor	Reinforced Concrete - Beam	0.200	1	E	Ground Floor	Reinforced Concrete - Ground Beam	0.300	1	1



TOBOKOTO, KSMD

GREATER BANJUL
THE GAMBIA

+220 3766269/2351601
Designed By: Structures Design
Drawn by: AH.Jow, A. O. Tamba & A. Marigo
Checked by: AH.Jow, A. O. Tamba & A. Marigo

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RevID	ChID	Change Name	Date

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SALAJI
N: WESTC

CLIENT: EARTH BUILDER'S ASSOCIATION

SITE: SAI REGION: COUNTRY:

WARNING NOTE

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PROJECT SITE AREA: 1000m²
Proposed Building Area: 285.448m²

DATE 5/22/2022

SCALE 1:2.70

S.01.4

Beam/Trenches schedule

	ELECTRICAL SCHEDULE												
Name	Ceiling Fan	Fan switch	Outdoor wall LAntern Lamp	(eilina l	Single Gang Switch		Tripple Gang Switch	Wall lantern Lamp	Wall Mount Lamp	Squared Ceiling Lamp			
2D Plan Preview		- 75 -		0	8	δ,	₫*		D				
3D Axonometry			•	0				#					
Quantity	8	6	4	6	11	3	1	1	9	14			
Home Story Name	Ground Floor	Ground Floor	Ground Floor	Ground Floor	Ground Floor	Ground Floor	Ground Floor	Ground Floor	Ground Floor	Ground Floor			



GREATER BANJUL
THE GAMBIA

+220 3766269/2351601

Designed By: Structures Design

Drawn by: A.H.Jow, A. O. Tamba & A. Marigo

Checked by: A.H.Jow, A. O. Tamba & A. Marigo

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ANT O	MISS	ION OR	ERROI	K 10 Str	uctur	es De	esigi	n
RevID	ChID	Change N	lame				Date	
CLIENT: EARTH BUILDER'S ASSOCIATION	SITE:	ä	COUNTRY: THE GAMBIA	THIS DRAWING AND INFORAMATION CONTAINED HEREIN IS OUR	INTERPRETATION OF WHAT IS NECCESSARY TO MEET YOUR WISHES AND SPECIFICATION IN ALL FACETS OF THE BRIEF REQUIREMENTS.	BY YOUR APPROVAL , THEREFORE THIS DRAWING AND ITS CONNOTATIONS HAVE BEEN FOUND/ ACCEPTED TO BE IN	CONFORMITY WITH THESE PARAMETER, THUS ANY FORM OF	MODIFICATION, INTENDED AND ADDED HEREAFTER, IS LIABLE TO

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THIS DRAWING IS NOT TO BE REPRODUCED BY ANY MEANS, OR HANDED OVER TO A THIRD PARTY WITHOUT PRIOR CONSULTAION WITH AND CONSENT OF STRUCTURES DESIGN

PROJECT SITE AREA: 1000m²
Proposed Building Area: 285.448m²

DATE 5/22/2022

SCALE 1:0.94

S.01.5
Electrcal Schedule